

Revision 1 - 20/10/2023

DRAWING STATUS
SALES STAGE

**PERSPECTIVES ARE FOR ILLUSTRATIVE PURPOSES ONLY. REFER TO SPECS & SELECTION FOR THE INCLUSIONS.

|--|

BUILDING SPECIFICATIONS: (TBC) CHANGE LOG: REVISION 1 ROOF: MONUMENT AUTO-SECTIONAL DOOR: COSMOPOLITAN - MONUMENT **GUTTER:** MONUMENT PORCH: 133 AXON LINED CEILING; EXP. AGG. FASCIA: MONUMENT ALFRESCO: VERSILUX LINED CEILING; EXP. AGG. SPOUT: MONUMENT MAIN FLOOR COVERING: HYBRID ALUM. WINDOWS & DOORS: MONUMENT POOL SIDE: 133 AXON SMOOTH - BLACK WALLNUT EXPOSED AGGREGATE: BEACHSIDE CLADDING: **SIGN HERE** FACE BRICKS: **VAULT GREY** CHANGING THE COLOURS OR MATERIALS ABOVE MAY HAVE COST IMPLICATIONS. IF CONFLICT ARISE BETWEEN THIS TABLE & COCONSTRUCT SPECS & RENDER: MARBLE MIST / MONUMENT DATE: SELECTIONS, PLEASE ALWAYS ASK & CONFIRM. STONE:

NEW RESIDENCE LOT 10 (14A) LOMANDRA COURT, YARRAWONGA, VIC 3730

SCALE @ A3

CHK. BY:

DWG. BY: KAS

REG. NO.: DB-U 28382

DRAWING NO. XX-XXXXX-WD00

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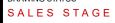


PERSPECTIVE



Revision 1 - 20/10/2023

DRAWING STATUS













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DATE:

NEW RESIDENCE LOT 10 (14A) LOMANDRA COURT, YARRAWONGA, VIC 3730

SCALE 1:1.90, 1:2.20, 1:2.30, 1:2.25, 1:2.53@ DWG. BY: KAS CHK. BY:

REG. NO.: DB-U 28382

DRAWING NO.

XX-XXXXX-WD00

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Lekeal QUALITY CUSTOM HOME BUILDERS

CONTACT:
Shop 3/59-63 Belmore St.,
Yarrawonga, Vic 3730 Ph: 03 5743 3896

www.lekeal.com.au

PERSPECTIVES

WALL & CEILING INSULATION:

-R2.0 WALL INSULATION TO EXTERNAL PERIMETER HOUSE WALL EXCEPT GARAGE EXTERNAL WALLS R4.1 CEILING INSULATION TO HOUSE


CONCRETE WAFFLE POD SLAB

EVAPORATIVE COOLING

DUCTED GAS HEATING





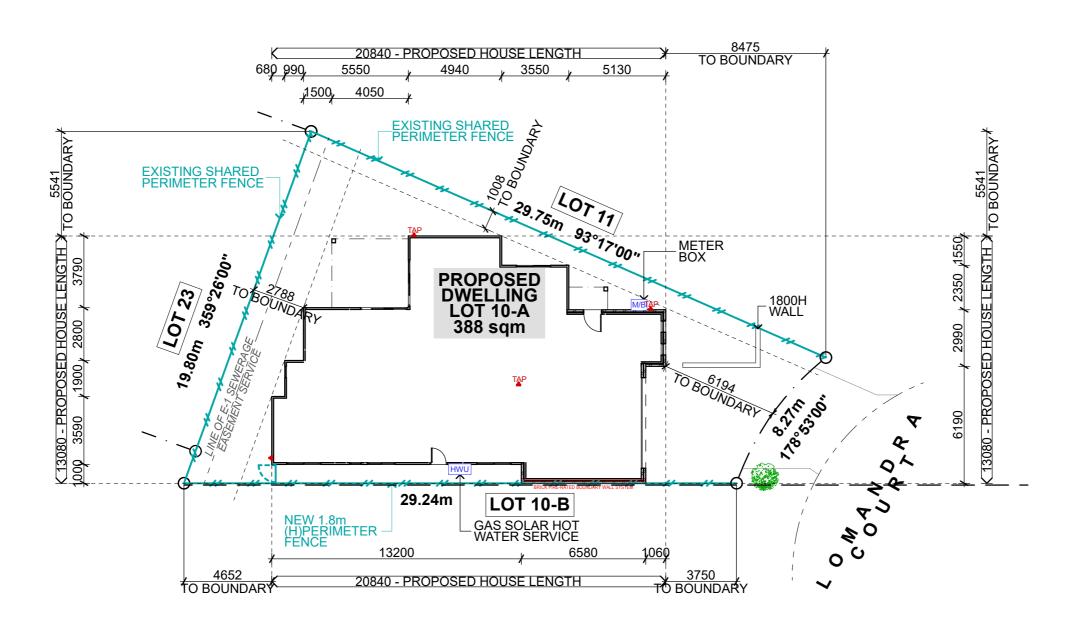

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DATE:

ISSUE DATE

Revision 1 - 20/10/2023

DRAWING STATUS SALES STAGE

NOTES:

All site dimensions are in meters unless specified otherwise and are shown approximate only.

For details of all esements, refer to the

subdivision plan or certificate of title and othe information by the responsible authority. Refer to plan of subdivision of all bearings, distances and other site information.
All stormwater, waste water and sewer / septic details to the requirements of the responsible authority.

Soil Type: Wind Category: BAL Compliance: Outer Area: Slab Thickness: P (TBC) N2 (TBC) N/A NO 100mm (TBC)

NEW RESIDENCE LOT 10 (14A) LOMANDRA

COURT, YARRAWONGA, VIC 3730

SCALE 1:200 @ A3

CHK. BY:

DWG. BY: KAS

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XX-XXXXX-WD01

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SET-OUT PLAN



WALL & CEILING INSULATION:

- R2.0 WALL INSULATION TO EXTERNAL PERIMETER HOUSE WALL EXCEPT GARAGE EXTERNAL WALLS - R4.1 CEILING INSULATION TO HOUSE


CONCRETE WAFFLE POD SLAB

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DRAWING STATUS

SALES STAGE

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All site dimensions are in meters unless specified otherwise and are shown approximate only.

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All stormwater, waste water and sewer / septic details to the requirements of the

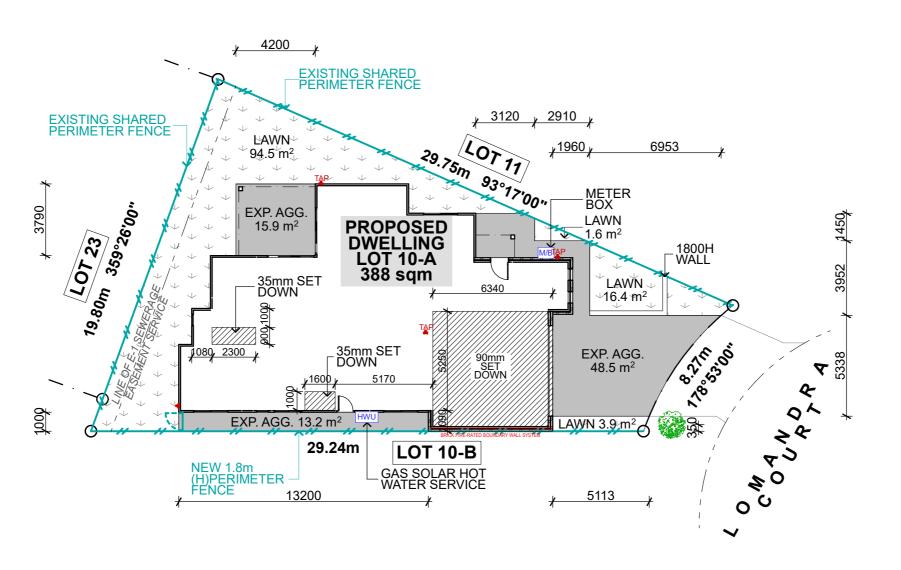Soil Type: Wind Category: BAL Compliance: P (TBC) N2 (TBC) N/A NO 100mm (TBC) Outer Area: Slab Thickness:

PLANNING SCHEME REQUIREMENTS

Garden Area Requirement: UP TO 500sqm=25%; 501-650sqm=30%; ABOVE 650sqm=35%

Site Area:

388 sam Garden Area Required (25%): 97.00 sqm Garden Area Proposed: 916.39 sqm

Permeable Area Required (20%):77.60 sqm Permeable Area Proposed: 102.58 sqm

SITE COVERAGE REQUIREMENTS

Maximum site coverage allowable (60%): 232.80 sqm Maximum site coverage proposed (54.87%): 212.89 sqm

NEW RESIDENCE

LOT 10 (14A) LOMANDRA COURT, YARRAWONGA, VIC 3730

SCALE 1:200, 1:2 @ A3

CHK. BY: DWG. BY: KAS

REG. NO.: DB-U 28382

DRAWING NO. XX-XXXXX-WD02




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Revision 1 - 20/10/2023

DRAWING STATUS

SALES STAGE

GENERAL NOTE: All dimesions, site and soil conditions to be verified on site, by the builder prior to orderi or placing any materials.

All work shall conform to the National

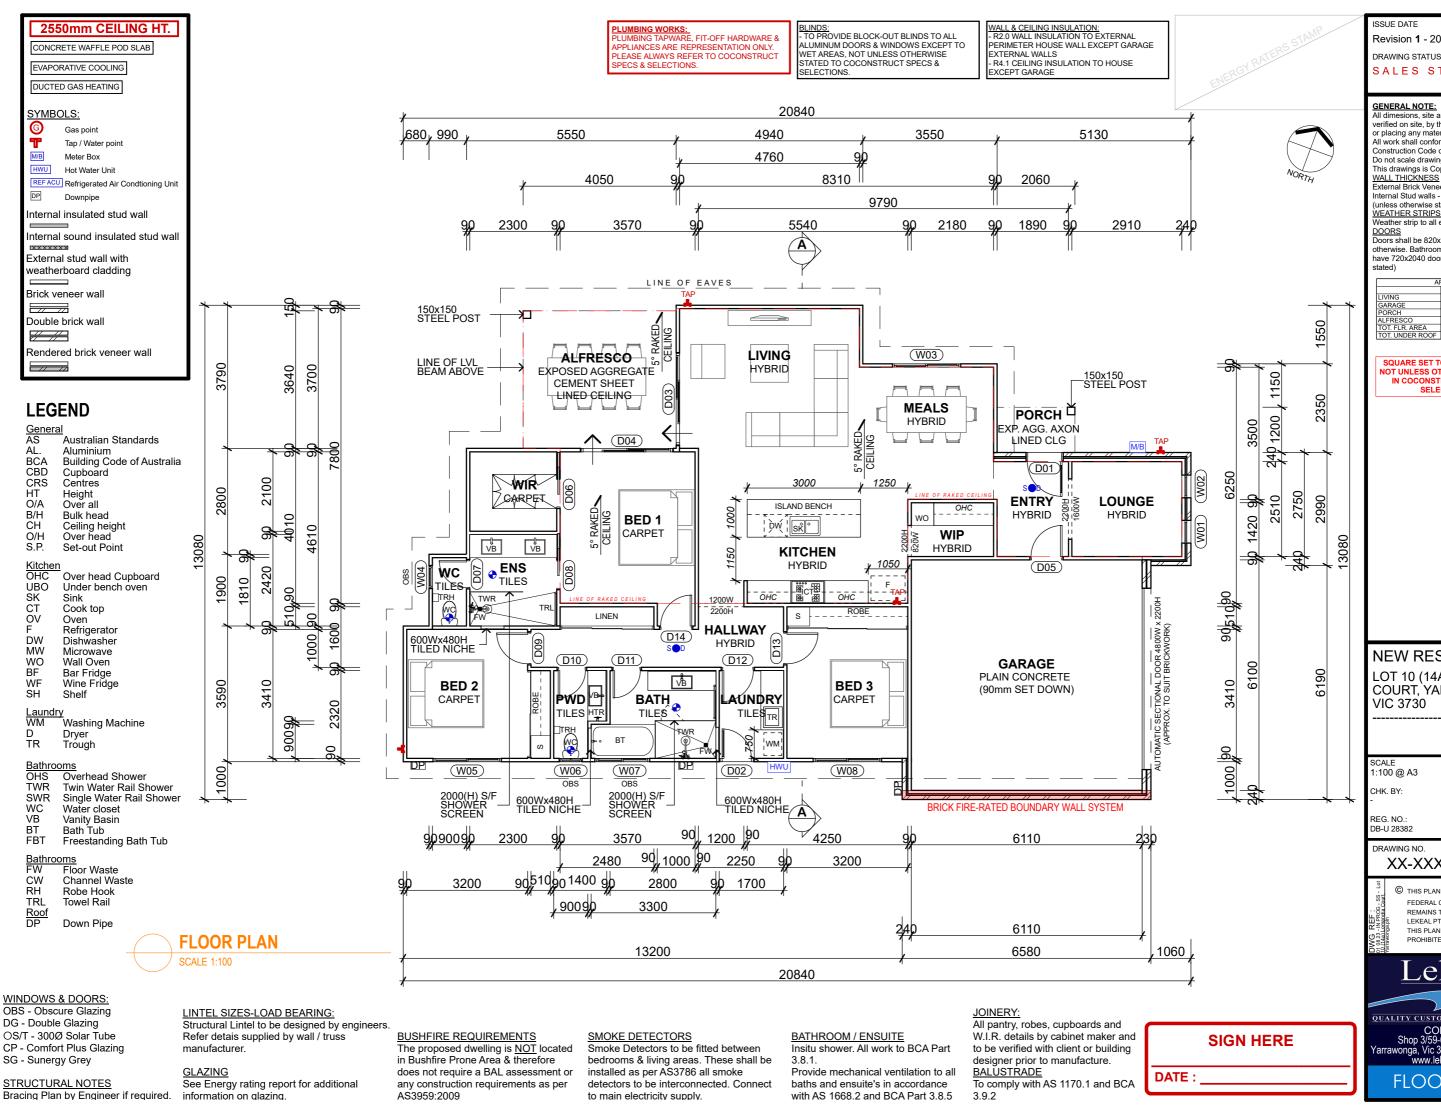Construction Code of Australia. Do not scale drawings. This drawings is Copyright.

Internal Stud walls - 90mm (unless otherwise stated)

WEATHER STRIPS Weather strip to all external hinged doors.

DOORS
Doors shall be 820x2040 unless noted

otherwise. Bathroom, Ensuite and Toilets sh have 720x2040 doors (unless otherwise

AREAS					
	SQM		EXT PERIM	l	
VING	153.58	16.53	54.07	l	
ARAGE	40.40	4.35	13.77	l	
ORCH	2.98	0.32	3.56	l	
FRESCO	15.92	1.71	7.99		
OT. FLR. AREA	212.89	22.92			
OT. UNDER ROOF	228.41	24.59	-	ı	

SQUARE SET TO ENTIRE HOUSE NOT UNLESS OTHERWISE STATED IN COCONSTRUCT SPECS & SELECTIONS

NEW RESIDENCE

LOT 10 (14A) LOMANDRA COURT, YARRAWONGA, VIC 3730

1:100 @ A3

DWG. BY:

DRAWING NO.

XX-XXXXX-WD03

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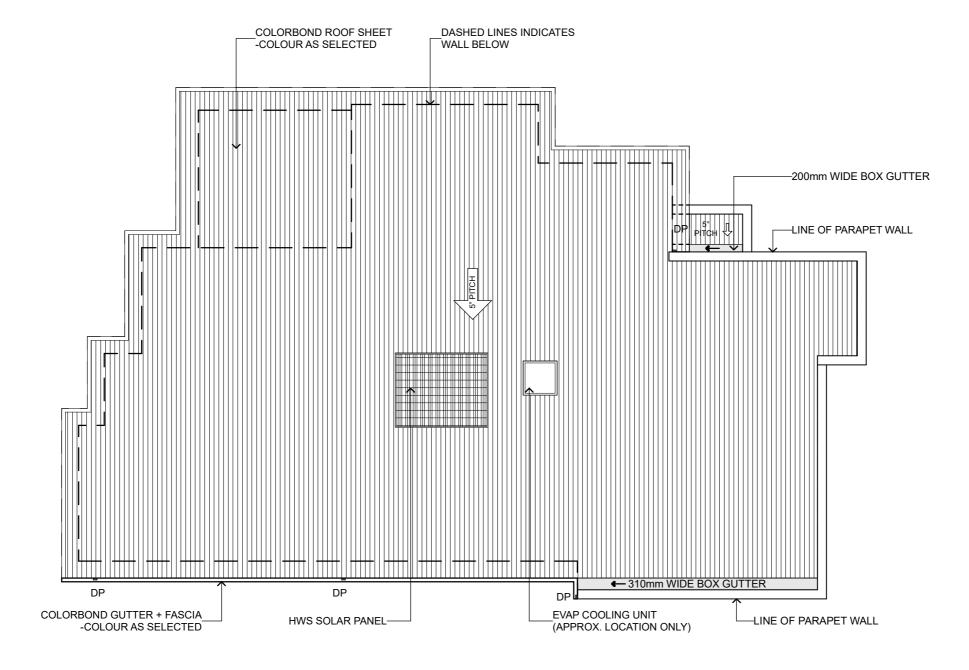
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FLOOR PLAN









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DRAWING STATUS

SALES STAGE

NOTES:

■DP Denotes colorbond downpipes. Downpipes at 12m cts. max. Locate a DP within 1.2m of any valley.

- - Dashed line denoted walls under.

Colourbond roofing installed to manufacturer's requirements and BCA regulations.

All roofing to comply with A3500. Make roof watertight.

Install sarking below all metal roofs. Extend sarking 50mm into gutters.

All box gutters to comply with SAA/SNZ 114

-Guidelines for Design of Eaves and Box Gutters

Turn throughs of all decking down 15mm at ends of all sheets.

- TO PROVIDE ROOF FLUE VENT FOR EXHAUST FANS & RANGE HOODS

- TO PROVIDE ROOF VENTILATIONS. VERIFY ROOF SUPPLIER FOR LOCATION

NEW RESIDENCE LOT 10 (14A) LOMANDRA

COURT, YARRAWONGA, VIC 3730

SCALE 1:100 @ A3

CHK. BY: DWG. BY: KAS

REG. NO.: DB-U 28382

DRAWING NO.

XX-XXXXX-WD04

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ROOF PLAN

FLOOR COVERING AREA					
ROOM NAME	FINISHES				
BATH	TILES				
BEDROOM 1	CARPET				
BEDROOM 2	CARPET				
BEDROOM 3	CARPET				
ENSUITE	TILES				
ENTRY	HYBRID				
GARAGE	PLAIN CONCRETE				
HALLWAY	HYBRID				
KITCHEN	HYBRID				
LAUNDRY	TILES				
LIVING	HYBRID				
LOUNGE	HYBRID				
MEALS	HYBRID				
PWD	TILES				
wc	TILES				
WIP	HYBRID				


CARPET

WIR

NOTE: -TO ALL EXTERNAL FLOOR COVERINGS, REFER TO CONCRETE & LANDSCAPE PLAN (WD02 SHEET)





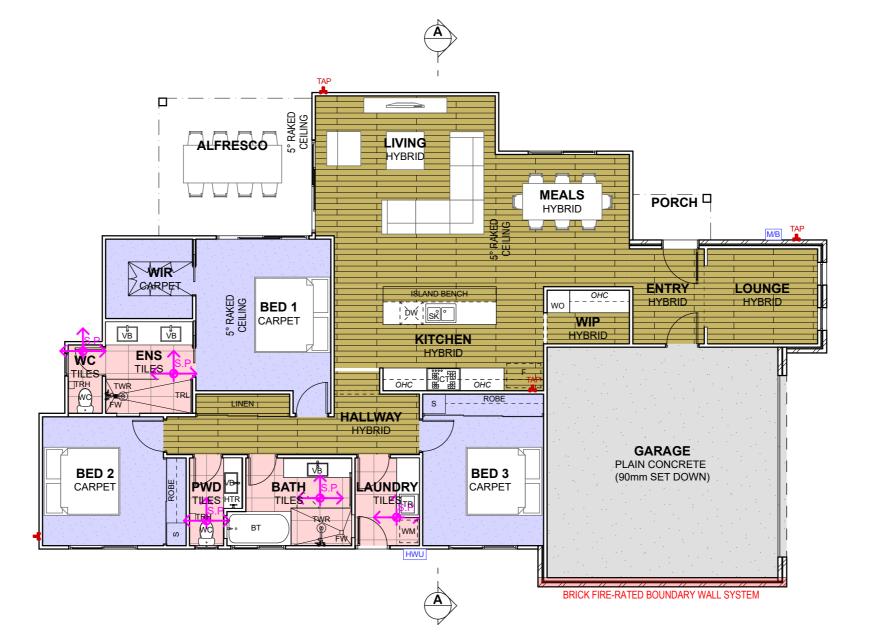

ISSUE DATE

Revision 1 - 20/10/2023

DRAWING STATUS

SALES STAGE

NOTES:

FLOATING TIMBER FLOOR PLAIN CONCRETE

FLOOR TILES

CARPET EXPOSED AGGREGATE

- ALL GROUTS TO BE CONFIRMED WITH THE TILER ON SITE.

-ALL WC IN SKIRTING TILES NOT UNLESS OTHERWISE STATED IN CPS.

WET AREA WALLS:
PROVIDE AN IMPERVIOUS
SUBSTRATE AND SELECT SURFACE
FINISH TO FLOORS WITHIN 1500MM
OF AN UNCLOSED SHOWER AND
SAME TO WALLS AT 1800MM ABOVE FLOORS AND 150MM ABOVE BATH, SINKS, BASIN AND TROUGH SPLASHBACKS AND THE LIKE. BCA PART 3.8.1

NEW RESIDENCE

LOT 10 (14A) LOMANDRA COURT, YARRAWONGA, VIC 3730

SCALE 1:100, 1:1.25 @ A3

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REG. NO.: DB-U 28382

DRAWING NO.

XX-XXXXX-WD05


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Revision 1 - 20/10/2023

DRAWING STATUS

SALES STAGE

SCHEDULE OF FINISHES

A. COLORBOND ROOF - COLOUR AS SELECTED

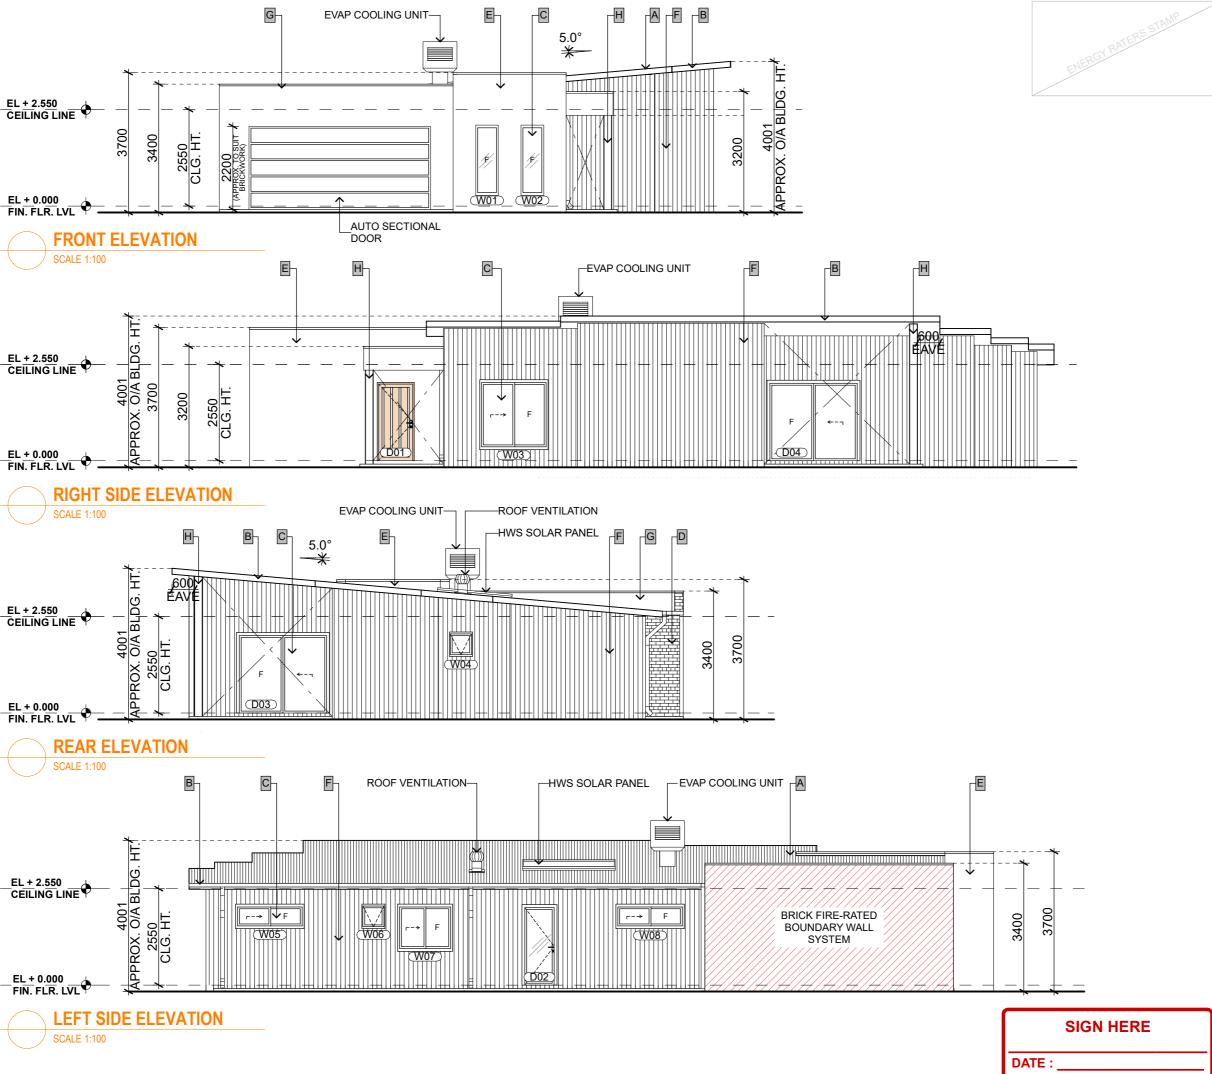B. COLORBOND FASCIA / GUTTER - COLOUR AS SELECTED

C. ALUMINUM P/C DOORS & WINDOWS

- COLOUR AS SELECTED BRICKS - AS SELECTED RENDERED - COLOUR AS

SELECTED
HARDIES FINE TEXTURE - COLOUR

AS SELECTED
RENDERED - COLOUR AS
SELECTED
STEEL POST - COLOUR AS

SELECTED

SOLAR PANEL / HWS PANEL / ROOF VENT / SKYLIGHT LOCATIONS ARE APPROXIMATE ONLY. VERIFY SUPPLIERS FOR LOCATIONS & CLIENTS TO CONFIRM ITS LOCATIONS.

NEW RESIDENCE

LOT 10 (14A) LOMANDRA COURT, YARRAWONGA, VIC 3730

SCALE 1:100 @ A3

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ELEVATIONS

PINE ROOF TRUSSES @900CRS. ENSUITE AND BATHROOM EXHAUST FANS TO BE VENTED TO OUTSIDE **WALL FRAMING:** PINE ROOF TRUSS SYSTEM DESIGNED BY MANUFACTURER-IN ACCORDANCE WITH BCA PART 3.8.5.0 **BUILDER TO USE** AND INSTALLED TO MANUFACTURER'S SPECIFICATION 90x35mm MGP10 STUDS AT 600mm CTS. ARCHITRAVES, SKIRTINGS & DOORS AS SELECTED ROOF: COLORBOND ROOFING PITCHED AT 22° WITH METAL TOP HATS @ 900mm CTS. 2/45x90mm MGP10 TOP PLATES TO LOAD BUILDER TO REFER TO TRUSS FABRICATOR DETAILS FOR LAYOUT AND CSR GYPROCK 10MM THICK TO WALLS AND CEILINGS ALL FIXED IN BEARING WALLS, 35x90 MGP10 BOTTOM ACCORDANCE WITH MANUFACTURER'S INSTRUCTIONS CORNICES AS PI ATF ALL ROOF FRAMING SHALL COMPLY WITH AS1684, PRE-FAB TIMBER ROOF SELECTED BY CLIENT JAMB STUDS - REFER TO TABLE. TRUSSES @ 900 CTS. BRACE WALLS WITH APPROVED SHEET CLAY BRICKS AS SELECTED WITH SELECTED MORTAR & JOINTING BRACES, ALL WALL FRAMING SHALL RFL AS SARKING TO UNDERSIDE OF ROOFING COMPLY WITH AS1684. NOGGINGS @ ALL BLOCKWORK IN ACCORDANCE WITH AS3700 AND BCA PART 3.3 DOUBLE SIDED RFL TO OUTER FACE OF EXTERNAL STUDS 1350mm CTS. MAX. MASONRY CONSTRUCTION PROPRIETARY WALL TIES IN BRICKWORK @ MAX 600CTRS IN EACH DIRECTION AND WITHIN 300MM OF DAMP PROOF COURSE TO EXTEND MIN 75MM ABOVE FLOOR LEVEL FIX TOP EDGE ARTICULATION JOINTS. ARTICULATION JOINTS IN BRICKWORK TO BCA OF DPC TO STUDS WITH CLOUTS OR PROPRIETARY FASTENERS PART 3.3 & BCA REFER TO ENGINEERS SLAB PLAN FOR LOCATIONS ALL TIMBER FRAMING IN ACCORDANCE WITH AS1684 AND BCA PART 3.4 FRAMING TO BE 90x35 & 90x45 MGP10 STUDS @ 450CRS WITH NOGGINGS AT MAX 1350MM LITEWEIGHT CLADDING AS SELECTED F17 LINTELS OVER ALL OPENINGS IN FRAMEWORK WHERE REQUIREDFRAME TO BE BRACED WITH PROPRIETARY METAL STRAP BRACING AND SHEET BRACING WHERE REQUIRED TO BCA PART 3.4 FRAMING AND AS1684 INSTALL SARKING **EVAPORATIVE COOLING** BARGE CAPPING **R4.1 CEILING INSULATION** UNDER ALL METAL -UNIT (APPROXIMATE TO MATCH ROOF (CHECK ENERGY RATERS) QUAD GUTTERING FIXED TO LOCATION ONLY) **ROOFS WITH CEILINGS** 190x33mm (NOMINAL) COLORBOND METAL FASCIAS; HWS SOLAR PANEL FALL 1:400 TO SELECTED (LOCATION TBC) **DOWNPIPES** ¥ 5.0° CONNECTION TO TRUSSES AS SPECIFIED BY ROOF FABRICATOR ROOF STRUCTURE TO ENGR'S DETAIL 10mm PLASTERBOARD LINING ON CEILING BATTENS AT 450mm CTS. FI + 2.550**CEILING LINE** 4001 APPROX. O/A BLDG. **ROOF STRUCTURE TO** -10mm PLASTERBOARD LINING ENGR'S DETAIL 2550 CLG. HT. R0.9 SISALATION PAPER (W02) Ш 0 LIVING KITCHEN BEDROOM 3 œ EL + 0.000 FIN. FLR. LVL REBATE DEPTH TO BE **1** IN MASONRY MODULES 0.2mm VAROUR BARRIER. TAPE BARRIER -WAFFLE POD AROÙND WALL PLUMBING ALL AROUND PENETRATIONS. 50mm LEVELING SAND SOIL INVESTIGATION AND CLASSIFICATION IN ACCORDANCE WITH AS2870. FOOTINGS TO AS2870 FOUNDED AT MIN. DEPTH BELOW REFER TO PLAN BY OTHERS SURFACE AS RECOMMENDED BY ENGINEER. REFER TO ENGINEERS FOR FOOTING & SLAB DESIGN PLAN FOR ALL SLAB DETAILS PROVIDE TERMITE PROOFING UNDER SLAB AND VERANDAH AND ANY OTHER CRITICAL AREAS RECOGNISED AS BEING SUSCEPTIBLE TO PROVIDE A CONTINUOUS IMPERMEABLE BARRIER WITH THE INFESTATION APPROVED TERMITE PROOFING METHOD TO BE CARRIED SARKING / HOUSE WRAP / REFLECTIVE FOIL. PAY PARTICULAR OUT BY CONTRACTOR IN ACCORDANCE WITH BCA AND AS 3660. ATTENTION TO: 1. TAPING ALL JOINS AND AROUND PENETRATIONS (SUCH AS PLUMBING SERVICES); 2. ENSURING THAT THE MATERIAL COVERS THE GAP BETWEEN STUDS AND DOOR & WINDOW FRAMES. IF FLASHING IS ATTACHED TO WINDOW FRAME, FLASHING SHOULD BE TAPED OVER SARKING / HOUSE WRAP / REFLECTED FOIL. **SIGN HERE**

ISSUE DATE

Revision 1 - 20/10/2023

DRAWING STATUS

SALES STAGE

NEW RESIDENCE LOT 10 (14A) LOMANDRA

COURT, YARRAWONGA,

1:50 @ A3

VIC 3730

CHK. BY:

REG. NO. DB-U 28382

DATE:

DRAWING NO.

XX-XXXXX-WD07

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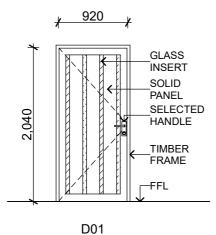
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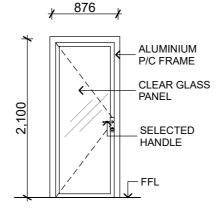
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SECTION

DOOR SCHEDULE				
DOOR NO.	DOOR NO. SIZE			
D01	920×2040	Н		
D02	876×2100	Н		
D03	2410×2100	Α		
D04	2410×2100	Α		
D05	820×2040	Н		
D06	720×2040	CS		
D07	720×2040	H*		
D08	720×2040	С		
D09	820×2040	Н		
D10	720×2040	H*		
D11	720×2040	Н		
D12	820×2040	Н		
D13	820×2040	Н		
D14	820×2040	Н		

2,100







BY SUPPLIER

ALUMINIUM

-P/C

FFL

FRAME




ENTRY TIMBER EXTERNAL SOLID PANEL HINGED DOOR

D02 LAUNDRY (EXT) ALUMINIUM POWDER COATED W/ CLEAR GLASS PANEL HINGED DOOR

LIVING ALUMINIUM POWDER COATED SLIDING DOOR W/ FIXED PANEL ALUMINIUM SLIDING DOOR

D03

2,410

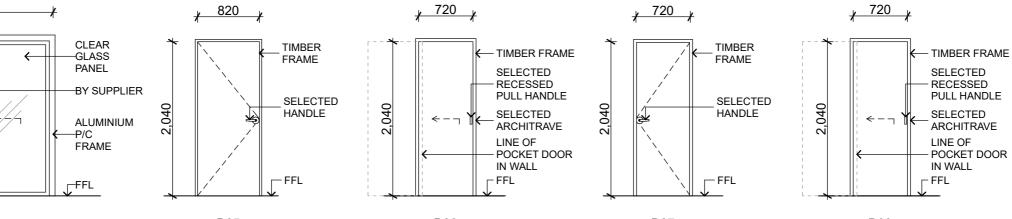


2,100

D04 BEDROOM 1 (EXT) ALUMINIUM POWDER COATED SLIDING DOOR W/ FIXED PANEL ALUMINIUM SLIDING DOOR


2,410



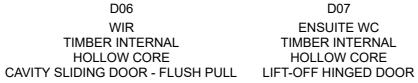

D07 **ENSUITE WC** TIMBER INTERNAL **HOLLOW CORE**

D08 **ENSUITE** TIMBER INTERNAL **HOLLOW CORE CAVITY SLIDING DOOR - FLUSH PULL**

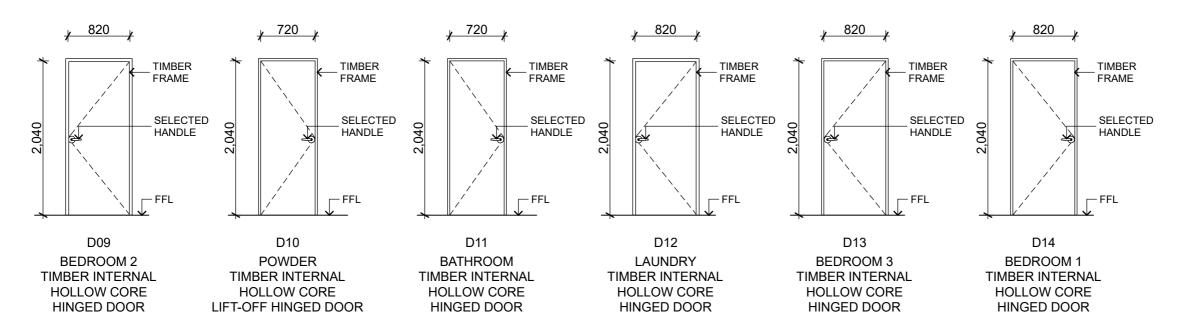

DOOR SCHEDULE SCALE 1:1

SIGN HERE DATE:

NOTES:

ISSUE DATE

DRAWING STATUS

HINGED DOOR CAVITY SLIDER REMOVABLE HINGES ALUMINUM P/C GLAZED DOOR PAIR HINGED DOORS PAIR CAVITY SLIDERS

Revision 1 - 20/10/2023

SALES STAGE

2H 2CS BD BI BARN DOOR BI-FOLD DOOR

WINDOWS & DOORS:

OBS Obscure Glazing

DG Double Glazing

CP Comfort Plus Glazing

SG Sunergy Grey

THESE DRAWINGS ARE FOR ILLUSTRATIVE PURPOSES ONLY. REFER TO SPECS FOR THE ACTUAL DOOR DESIGN & HANDLES

NEW RESIDENCE LOT 10 (14A) LOMANDRA COURT, YARRAWONGA, VIC 3730

SCALE 1:1 @ A3

CHK. BY: DWG. BY: KAS

REG. NO.: DB-U 28382

DRAWING NO. XX-XXXXX-WD08

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DOOR SCHEDULE





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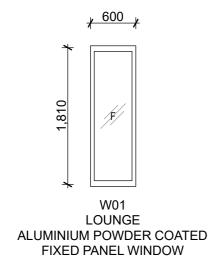
Revision 1 - 20/10/2023 DRAWING STATUS SALES STAGE


- CONFIRM ALL SIZES PRIOR TO ORDERING AS PER SITE MEASUREMENTS


WINDOWS & DOORS:


OBS Obscure Glazing
DG Double Glazing
CP Comfort Plus Glaz
SG Sunergy Grey

Comfort Plus Glazing




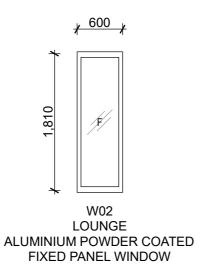


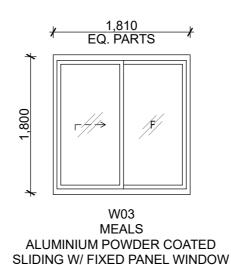


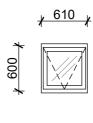


W04 WC ALUMINIUM POWDER COATED **AWNING WINDOW** FROSTED GLASS

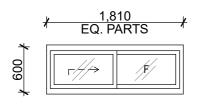

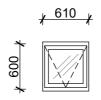

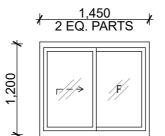

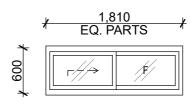

W05 BEDROOM 2 ALUMINIUM POWDER COATED SLIDING W/ FIXED PANEL WINDOW

W06 **POWDER** ALUMINIUM POWDER COATED **AWNING WINDOW** FROSTED GLASS

W07 BATHROOM ALUMINIUM POWDER COATED SLIDING W/ FIXED PANEL WINDOW FROSTED GLASS

W08 BEDROOM 3 ALUMINIUM POWDER COATED SLIDING W/ FIXED PANEL WINDOW THESE DRAWINGS ARE FOR ILLUSTRATIVE PURPOSES ONLY. VERIFY SUPPLIER FOR THE STANDARD WINDOW DESIGN, UNLESS CLIENT(S) WANTED A NON

NEW RESIDENCE LOT 10 (14A) LOMANDRA COURT, YARRAWONGA, VIC 3730

SCALE 1:1 @ A3

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DRAWING NO.

XX-XXXXX-WD09

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WINDOW SCHEDULE SCALE 1:1

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Internal power outlets to be located 300mm above the floor (or becnh top) unless it serves a specific appliance such as a refrigerator or dishwasher where the position shall be appropriate for the equipment.

External & garage power outlets to be located 1000mm above floor. Power for garage doors to be located next to garage door motor. Powerpoints & light control switches shall be located next to garage door motor.

Light control points shall be located 1000mm from the floor.

All light fittings (expect where noted otherwise) shall be supplied and installed by the builder.

TV aerial to be supplied and installed by owner after completion of contract.

Provide power to all appliances that require power such as heaters, coolers and stoves.

All work to comply with AS3000 and the Supply Authorities requirements. Telephone connection fees by owner.


Meter box to be metal. Electrician to liase with Client to check if NBN & associated data point connection is required to future proof house.

Smoke detectors to be interconnected as per regulation 3.7.2.2 (d) of the NCC.

Flow rates & discharge of exhaust systems to be in accordance with NCC 2019 VOlume Two, Clause 3.8.7.3.

Building insulation abutting or is within 100mm horizontally of the luminaire must meet the following reuirements: Be of a type that can maintain its dimensions and structural integrity when exposed to a maximum surface temperature of the class of the luminaire, being 90°C; Be of a type that can withstand a 30 second needle flame test carried out in accordance with AS/NZS 60695.11.5 with a flame applied to all surfaces of the sample. Insulation types which should ne used this fitting are glass wool (Pink Batts) & polyester.

IMPORTANT NOTE: BUilder must NOT install loose fill insulation, such as wool or macerated paper. Fixture Driver or COntrol Gear must be mounted <u>above</u> any insulation covering the fixture.

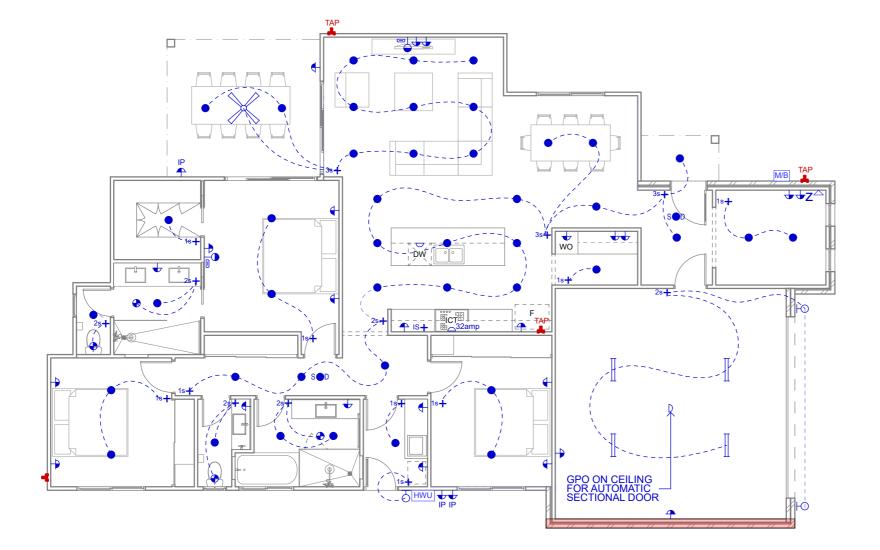

ARTIFICIAL LIGHTING TO COMPLY WITH N.C.C.3.12.5.5				
WATT RATIO	ZONE	AREA	MAX. WATTS	
HOUSE AREA 5W/m²	LIVING	153.83m²	769.15 W	
COVERED	PORCH	2.98m ²	11.92 W	
AREA 4W/m²	ALFRESCO	15.92m²	63.68 W	
GARAGE AREA 3W/m²	GARAGE	40.40m²	121.20 W	
	TOTAL	212.89m ²	965.95 W	



POOL & PUMP SHED:
- PROVISION OF POWER & PLUMBING
- BACKWASH & WATER LEVELLER CONNECTION TO BE INCLUDED



ISSUE DATE Revision 1 - 20/10/2023 DRAWING STATUS SALES STAGE

LEGEND

		"174
	POWER	QTY.
۵	SINGLE GPO	1
32amp	SINGLE GPO - 32AMP	1
4	DOUBLE GPO	23
∩ _P	SINGLE GPO IP RATED	-
4 _{IP}	DOUBLE GPO IP RATED	3
O —	TV POINT	2
M/B	METER BOX	1
Z	TELEPHONE POINT	1
HWU	HOT WATER UNIT	1
#	USB GPO	-
	FLOOR MOUNTED DOUBLE GPO	-
\triangleright	DATA POINT	1
##-	TV AERIAL ANTENNA	1
0	HDMI	2

	<u>LIGHTING</u>	QTY.
+ _{1s}	1-GANG SWITCH	9
+ _{2s}	2-GANG SWITCH	6
+ _{3s}	3-GANG SWITCH	3
+₀	DIMMER SWITCH	-
+ _{is}	ISOLATION SWITCH	1
2-	TWO-WAY LIGHT SWITCHING	-
3- ′	THREE-WAY LIGHT SWITCHING	-
//	ELECTRICAL WIRING	-
오	WALL MOUNT LIGHT	3
•	DOWNLIGHTS - LED	43
8	DOWNLIGHT W/ SENSOR	-
ш	FLUORESCENT LIGHT	4
•	EXHAUST FAN	4
88	IXL TASTIC	-
$ \times $	FAN ONLY	1
X	FAN / LIGHT	-
SOD	SMOKE DETECTOR	2
	LED STRIP LIGHT	-
⊕ _{0/S}	PENDANT FEATURE LIGHT	-
•	SPOTLIGHT W/ SENSOR	-
Ŷ U/D	UP-DOWN WALL LAMP LIGHT	-
\$2	DOUBLE ENDED SPOTLIGHT	-
*	CHANDELIER	-
	ILLUME	-

	<u>OTHERS</u>		
G	GAS POINT	-	
T	TAP	4	

SIGN HERE

DATE:

NEW RESIDENCE LOT 10 (14A) LOMANDRA COURT, YARRAWONGA, VIC 3730

SCALE 1:100 @ A3 CHK. BY:

DWG. BY: KAS

REG. NO.: DB-U 28382

> DRAWING NO. XX-XXXXX-WD10

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ELECTRICAL PLAN






DRAWING STATUS SALES STAGE


Revision 1 - 20/10/2023


NOTES:

ISSUE DATE

- SUBJECT TO CHANGE AFTER ON SITE MEASURE BY OUR SHELVING & ROBE CONTRACTOR

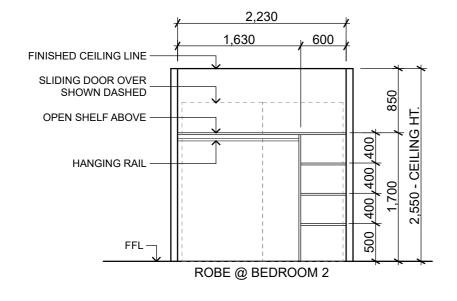

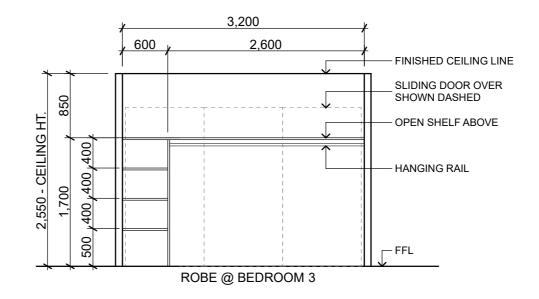

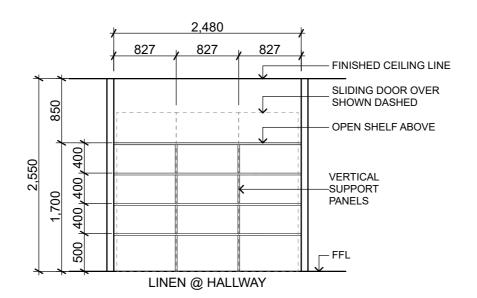

THESE DRAWINGS ARE FOR ILLUSTRATIVE PURPOSES ONLY

NEW RESIDENCE LOT 10 (14A) LOMANDRA COURT, YARRAWONGA, VIC 3730

SCALE 1:50 @ A3

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DRAWING NO.

XX-XXXXX-WD11

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SHELVING DETAILS

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GENERAL NOTES



ISSUE DATE
Revision 1 - 20/10/2023
DRAWING STATUS

SALES STAGE

ENERGY RATING NOTES

New Work

The Builder shall refer to the Energy Rating Report for details.

All glazing shall be as per the Energy Rating Report.
All windows shall be fitted with the seals on all 4 sides.

All exhaust fans shall be self closing.

All external swing doors & internal doors in house / garage walls shall be fitted with Raven compressible rubber door seals at the top and sides. At the bottom of all swing doos, install a Raven flap seal.

All roof lights to be sealed with a weatherproof seal

Refer to the Section on the Plans for details of wall insuation and ceiling insulation.

For Energy rating purposes, we have assumed a 225mm / 300mm deep minimum waffle pod will be used. If the slab is a raft slab then the Energy rating will need to be modified.

OWNERS NOTES

Owners should be maintain their buildings in accordance with the CSIROs Home Owners Maintenance manual.

Clay soils will swell, and shrink with variations in moisture content. This movement may cause damage to the building.

In order to minimise the damage, we recommend the following precautions be taken -

- 1) Provide adequate site drainage to ensure water will not pond against or near the building.
- 2) Grade the site within 2 meters of the building, away from the building, to ensure that no water ponds near the building.
- 3) Maintain sewage and stormwater systems to ensure no leakage occur. If they occur, repair them promptly.
- 4) Trees and shrubs should not be planted or allowed to exist, closer than 0.75 times their mature height.

Avoid establishing garden beds next to the building. Gardens and lawns should be watered adequately but not excessively. Uniform consistent watering can be important to prevent damage to the foundations during dry spells or droughts.



BUILDERS NOTES

STANDARDS

The Builder shall ensure the building complies withthe following Regulations & Standards

Building Code of Australia

AS 1562 Roofing

AS 1288 Glazing Code

AS 2870 Slabs and Footings AS 3500 Plumbing Code

AS 3660 Termite Code

AS 3000 Termile Coul

AS 1684 Timber Framing

AS 3730 Waterproofing Code

and all other standards nominated in the NCC

SITE LEVELS

The Builder shall ensure the building is built at a minimum of 450mm above any adjoining ground level.

The Builder shall grade the soil away from the building at a rate of 50mm for every meter for at least 2 meters to ensure any surface water will not pond against the building.

If there is a Flood Level nominated on the site, the building shall be built to the minimum floor level nominated by the Building Surveyor.

MASONRY

Incorporate Control Joints (or full height openings) in all masonry walls at a maximum of 4.5 meters cts. Locate additional joints inmasonry directly over junctions in footings which are different types, eg. at House / Garage

TERMITE PROTECTION

Treat building for termites as per AS 3660.1. Use termite resistant T2 framing (walls, trusses & all primary building elements) throughout proposed works.

Install Homeguard Blue termite collars around all plumbing penetrations thru slab.

TIMBER EXPOSED TO WEATHER

All timber exposed to weather, but not in ground, shall be to H3 classification.

All timber in ground to be H5 classication.

GLAZING - BATHROOMS, ENSUITES & SPA ROOMS

All windows within 2000mm of the floor shall have Safety glazing as per AS 1288 - 2006 SEC 5-5.8

FLOOR TILES

MInor movement shall inevitably occur in most floors. In order to minimise any damage to floor tiles as a result of floor cracking / movement a flexible adhesive shall be used.

DOORS

Door sizes shall be as per floorplan unless noted otherwise.
Bathroom, Ensuites & Toilets shall have door sizes as per floor plan.
Toilet cubicle doors shall be fitted with removable hinges.

SMOKE DETECTORS

Smoke detectors are denoted S D on the plan. These shall be installed as per AS 3786. Where more than 1 detector is installed, they shall be interconnected electrically. Connect to main electricity supply.

BUILDERS NOTES (cont'd)

ASBESTOS

If any possible Asbestos material are found, they should be checked and tested. If confirmed, it must be removed by a licensed contractor in accordance with Worksafe quidelines.

DRAINS

Piping trenches running parallel with the Building should be located at an offset from the footing equal to the depth.

STAIR DETAILS (if required)

Riser Height - Min. 115mm, Max. 190mm Tread Going - Min. 250mm, Max. 355mm

Minimum Vertical Clearance - 2000mm Install 1x handrail 900mm above nosing for dwellings

BALUSTRADES

(applicable for landings, Balconies & Verandahs 1000mm minimum above the ground level)

<u>HEIGHT</u>

865mm minimum above stair tread nosings 1000mm maximum above finished floor level

OPENING

Constructed so a 125mm sphere cannot pass through.

NOTES FOR ENGINEERS

The Engineer engaged to carry out the design of the slabs and footings shalls design the system in accordance with AS 2870, AS 3600, NCC, the Soil Test and all other site conditions such as cut/fill which may exist on the site.

The Engineer shall take into consideration trees and underground pipes which exist or may exist in the future.

The Engineer shall collect information on all the piping systems, sewer mains, plumbers sewer drainage pipes, stormwater pipes, etc., slab heating (electric / hydronic if applicable) and design his slab / footings accordingly.

The Engineer shall liase directly with the Sewer Authority, plumber, client and builder to obtain the above information.

The Engineer engaged to carry out the design of the slabs / subfloor shall take full responsibility for the above.

Lekeal Pty. Ltd does not accept any responsibilty for the Engineer's work.

DESIGN WORK BY ENGINEER

Soil Test

Footing Design

Misc. Steel Beams shown on Plans

Column to support steel beams

- Other items needing Engineering Design

Upper Floor floor joist (if applicable)

Bracing details

THIS SITE - SOME OF THE ISSUES

Engineer to note

Sewer mains and plumbers sewer drainage pipes near footings

Isolated patches of fillExtensive fill on site

Cut / fill site

Large tree stump holes under building

Sloping Site

BRACING PLAN

Bracing Plan by Engineer if required

These are only some of the issues to be considered in the footing design. This is not a complete list of issues. The Engineer shall investigate all the issues which may effect the design and ensure that the design is appropriate and structurally sound.

The Engineers shal forward a copy of Plans, Soil Tests, Computations etc. to Lekeal Pty. Ltd.

NEW RESIDENCE

LOT 10 (14A) LOMANDRA COURT, YARRAWONGA, VIC 3730

DWG. BY:

SCALE @ A3

CHK. BY:

REG. NO.:

DB-U 28382

XX-XXXXX-WD12

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GENERAL NOTES

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BUILDING SPECIFICATIONS - GENERAL

GENERAL CLAUSES

All work shall comply with the Buildign Code of Australia, State Government Regulations and any relevant local Government bylaws applying to the work. All work shall compy to the relevant standards for that particular trade.

Owner - Shall mean the owner of the building, proprietor or client. The word builder shall also mean contractor

Making Good - The builder shall be responsible for any damage to adjoining roads, pavement or properties. The builder shall make good any damage at his cost.

Temporary services - The builder shall provide necessary temporary services such as electricity, water and sanitary accomodation. Drawings - The builder shall keep on site, in good order 1x set of plans and specifications.

Materials - All materials shall be new and comply with the relevant sections of the Australian Standards.

Notices and Fees - The builder shall pay for all fees and notices (except planning permit fees) for the work to be done.

<u>Clean Up</u> - The builder shall be responsible for cleaning up the building site of any excess soil, unused materials, etc. prior to the handover.

Site - The owner shall be responsible for clearly identifying the site, with a licensed surveyor if necessary. The builder shall locate the house within the identified site as per plans.

Allowances - The builder shall allow in his price, the prime cost allowances nominated. Where items are 'Supply only' the builder shall allow in the contract sum for the labour cost to install the components. Should the expenditure exceed the allowance, the owner shall pay the builder the extra amount plus 10% of the extra amount. Should the expenditure be less than the allowance, the builder shall credit the owner the difference.

EXCAVATOR

The owner at his expense, shall clear the site of any obstructions, likely to interfere with the building works, prior to the commencement of the building.

Excavation - The builder shall excavate fo footings, etc. as per the Engineer's plans, soil report and Architectural plans. The builder shall excavate for stowm water and sewer pipes required to service the building. All excavations for piped shall be back filled with approved material.

Surplus Materials - The builder shall remove all surplus material from the site at his cost. The builder may leave surplus material on the site if directed by the owner

<u>Inspections</u> - The builder shall organise appropriate inspections of the founding material below the footings by the building surveyor or

CONCRETOR

Inspections - The builder shall organise appropriate inspections of the slab reinforcing, prior to pouring concrete, by the building Survey or Engineer.

Concrete - All concrete shall have minimum strength of 25Mpa at 28 Days It shall have a maximum slump of 80mm

Reinforcement - All reinforcement shall be in accordance with Australian Standards 1302, 1303, 1304 & 1480. All slab mesh shall have 25 cover to the top.

Standard - All work shall be carried out to ensure complaince with Australian Standard 2870 and to the Engineer's drawings. Footings and verandah posts - See Engineers Plan

Finish - The finish shall be steel trowelled, approriate for the final

Verandah and Foothpaths - Unless noted otherwise on the plans, use 100mm thick slabs with SL72 mesh in the top for non-filled areas. See engineers drawings for slabs overfilli. Install tooled control joints at 1.2 meter cts. for the length of the slab. Fall verandahs and footpaths to create cross fall.

Garage slab - See plans

Moisture barrier - All slabs shall be protected from moisture penetration from below with a 0.2mm plastic vapour barrier. Lap and tape all vapour barriers. Tape barrier around plumbing penetrations to eliminate any chance of moisture penetration.

MASONRY

Set-out - All masonry shall be set out with a gauge rod to enusre every course is horizontal. The masonry shall be laid with a stretcher bond. All perpends in every 2nd course will line up

Standard - All masonry shall comply with Australian Standard 3700. Sills - All sills will be brick on edge, set 30° to the horizontal and shall overhang the wall by 20mm

Mortar - The colour and type of the mortar shall be nominated by

Lintels - All steel Lintels supporting Masonry shall be galvanised in accordance with Australian Standard 3700. Lintels shall have an end bearing of 200mm

Door sills - All door sills shall be brcik on edge.

Damp proof courses - All masonry shall have an approved damp proof course to prevent the movement of damp vertically up brickwork. The builder may use an approved chemical damp proof course mixed and used as per the manufacturer's recommendations or embossed opaque plythene film a minimum of 0.25mm thick. Wall ties - All wall ties shall be installed as per Australian Standard 2699 - See plans.

Cleaning - Point up all flashings, pipe penetrations, etc. Clean brickwork with spirits of slats diluted to a maximum of 1 in 10. Wash down Masonry with water after cleaning

CARPENTRY

All timber used shall comply with Australian Standards 1684 and

Frames - See plans for stud and plate sizes. Install studs at all jambs as per Australian Standard 1684. Secure bottom plate to slab with concrete nails at 600 cts. All walls shall be erected plumb, square and true in line. All studs shall be straightened, if require prior to lining, See Australian Standards 1684 for sheet bracing or metal angle wall braces.

Shower recess - Check wall to suit shower base nominated on

Bath - Check wall to suit bath. Make water tight.

Eave and verandah lining - Where shown on the drawings, install 4.5mm cement sheet lining, joined with PVC cover straps. Fix sheets to 90x35mm MGP 10 pine at 450mm cts. or as per plans. All tiled roofs to have lined verandahs. All eaves are to be lined. Roof trusses - Supply and install prefabricated roof trusses as per manufacturer's design. Supply and install tie downs, girder truss, connector plates strictly as per manufacturer's specifications. Architraves and skirtings - To be selected by owner. Supply and install a skirting board at all floor / wall junctions. Supply and install an architrave around every door and window. Neatly mitre achitrave's at corner

Door frames - Supply and install one ex 150x38mm H.W. or meranto solid door frame around the perimeter of every external door. Door stops to be 50x10mm (nominal). Internally supply and install a 110x25 H.W. door frame with a 30x10 door stop. Secure frames to studs. Fix frames level and true.

<u>Cavity doors</u> - Supply and install built-in robes where shown on plan. Install 1x Melamine shelf 1700mm from floor and 1x chrome hanging rail suspended from shelf for each robe. At one side of robe supply and install 600mm wide adjustable shelving. Supply and install Melamine shelves normally spaced at 400cts. Line the inside of robes with plasterboard as per remainder of house. Paint inside of cupboards. Fix door jambs to perimeter of door openings to robes together with architraves mitred at corners

TIMBER EXPOSED TO **WEATHER**

All timber exposed to weather, but not in ground, shall be to H3 classification.

All timber in ground to be H5 classification.

Linen press - Supply and install linen press where shown on plans. Install melamine shelves at 400mm cts. (nominal)

Broom cupboard - Supply and isntall a broom cupboard with 1x melamine

Joiner - Supply and install kitchen cupboards and other joinery wher shown on plan. Finishes as per plans. Install a 50mm deep x 100mm high kick recess at base. Joinery to be manufactured by an approved cabinet maker. Install a bulkhead over overhead cupboard. See plans for number of drawers. In top cutlery drawer install a plastic cutlery tray. All cupboard doors to have concealed adjustable hinges.

Vanity Units - unless noted otherwise on plans, all vanity units to be fabricated by a joiner.

ROOFING

The builder shall supply and install roofing as per plans in accordance with the relevant Australian Standard. All ridge & hip tiles and valley gutters shall match the roof colour. Where sheet roofing is nominated on the plans, the roofing shall be installed strictly as per the manufacturer's recommendations. All sheet roofing to be Custom Orb unless noted otherwise. in one length. Water Tight - It is reponsibility of the builder to ensure the building is completely water tight.

Gutters - Supply and install gutters as per plan. Fall gutters 1:400 to downpipes. All gutter joins to the sealed. Install downpipes to pops from gutters. Attached gutters to walls at 900 cts. with straps fixed to wall. All flashings shall be either lead flashings or 0.6mm metal.

PLUMBING

All plumbing to be carried out by the licesed plumber in accordance with AS 3500 and the relevant plumbing regualtions. Water supply shall be extended from the front of the site of the house. If a tapping is required from the mains, it shall be done at the owners expense. The builder shall assume the point of supply for water is within 15meter from the house. If it is greater than 15meters, the owner shall bear the additional cost. For houses without access to a water main the builder shall allow for the 15meter of line as above. The costs of pumps and tanks, etc. unless noted otherwise, shall be borne by the owner. Install a stop cock to enable the water supply to the house to be controlled. Garden Taps - The builder shall allow for 4x garden taps for the house, which will be attached to the house unless noted otherwise. 2x tap will be at the front and 2x will be positioned at the rear of the house. The owner shall approve the exact positions prior to installation.

Hot Water Service - If electric hot water services is installed, the builder shall install a 315 litre Thermann or approved similar. Where a natural gas hot water service is installed, the builder shall install a 26L Thermann continuous flow / Rinnai unit or simliar approved. Where a solar hot water service is installed, the builder shall install a 315 Thermann / 270 L or 320 L Rinnai solar gas boosted unit or approved similar. Install a HWS strictly as per manufacturer's recommendations. All hot water services shall be mains pressure

Taps - To be nominated by owner

Sanitary Plumbing - All sewerage work shall be carried out by a registered plumber approved by the local authority with control over the work. Any fees and charges associated with the work shall be paid for by the builder. In areas which are not sewered, install a septic system to the approval of the local authority which has control over the work. See Inclusions Sheet

Drainage - The plumber shall install stormwater pipes to connect to all the downpipes and discharge point approved by the local authority having control over drainage matters. All pipes shall be 90ø PVC falling in 1 in 400 meters minimum to the point of discharge. Provide a minimum of 200mm cover at high end. Seal all pipes with appropriate glue.

Sloping Sites - On all sites on which the land falls to the building. the builder shall install agricultural pipes embedded in 12mm crushed rock, & earth surface drains which ensure surface water & sub-surface water will not pond against or near the building. Gas Piping - All gas pipes and fittings shall be installed as per the Authorities regulations, with control over the works requirements. The work shall be carried out by a registered gas fitter. The builder shall extend the gas line from the appliances nominated as gas appliances (See Inclusions Sheet), to the source of supply. All gas pipes shall be appropriately sized to suit the requirements of the appliances being served, and the requirements of the gas regulations.

ELECTRICAL

All work shall be carried out by a registered electrician in accordance AS 3000 & with the authority with jurisdiction over the work. The electrician shall give appropriate notices, pay fees and obtain any required inspections of the work, prior to handover of the building.

Meters - The builder shall co-ordinate with the supply authority to ensure that a waterproof cabinet, by builder, is installed at an appropriate location for the installation of the meters.

Wiring - Wire to all light fittings, power outlets and appliances requiring direct connections. Provide provision to switchboard. All wiring shall be concealed

Consumer Mains - Supply and install a mains, from the point of supply from the electricity supplier to the building. At the tender stage the builder shall determine the type of mains allowed-either underground or overhead and allow this in his tender price. <u>Light Control Points</u> - Locate light switches 1000 from floor. GPO's - Locate GPO's 300 from floor or 150 from the bench tops. TV Outlets - Install TV points as per plan and extend line into ceiling space with 7 meters of spare line provided for connection to aerial. Aerial is not in contract.

PLASTERER

Plaster - Supply and install flush set plasterboard to all walls and ceilings throughout the entire building unless noted otherwise on the plans To the wet areas use water resistant plasterboard. At all corners install a metal backing angle. See plans for plaster thickness. All plasterboard shall be installed strictly in accordance with the manufacturers recommendations. Cornices - To be selected by owner.

TILING

Extent - Extent of wall tiling to be confirmed by owner. See Plans for extent of floor tiles.

150 min high skirting tiling to wet ares. See plan for extent of floor

Adhesives - The builder shall use adhesives in accordance with the manufacturer's recommendations. Use flexible adhesives for floor

Tiles - To be selected by client. Grout colours to be nominated by

PAINTING

Extent - Paint all fascias, downpipes, verandah posts, eaves lining, doors, plasterboard, skirting, architraves and any other surfaces which are not pre-finished.

Standard - The builder shall apply a minimum of 2x coats to ensure that no blemishes or streaks occur. The builder shall apply additional coats if required. All work shall be carried out in accordance with the paint manufacturer's recommendations for preparation and application of the paints. Colours - To be nominated by client.

Paint Type - External

2 coats of gloss acrylic Timber and metal -Downpipes 2 coats of gloss acrylic 2 coats of matt acrylic Eaves

Paint Type - Internal

2 coats of gloss enamel Doors Skirting & Architrave -2 coats of gloss enamel Walls 2 coats of Wash N Wear acrylic Ceiling 2 coats of matt acrylic

CLEAN UP

The builder shall remove from the site any unused uilding materials, rubbish, etc. The builder shall level the site of any surplus soil, etc. The builder shall clean the windows & house generally, ready for occupation

DATE:

SIGN HERE

ISSUE DATE Revision 1 - 20/10/2023

DRAWING STATUS SALES STAGE

NEW RESIDENCE LOT 10 (14A) LOMANDRA COURT, YARRAWONGA, VIC 3730

SCALE @ A3

CHK. BY: DWG. BY

REG. NO.: DB-U 28382

DRAWING NO XX-XXXXX-WD13

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Revision 1 - 20/10/2023

DRAWING STATUS SALES STAGE

**PERSPECTIVES ARE FOR ILLUSTRATIVE PURPOSES ONLY, REFER TO SPECS & SELECTION FOR THE INCLUSIONS.

|--|

BUILDING SPECIFICATIONS: (TBC) CHANGE LOG: REVISION 1 ROOF: MONUMENT AUTO-SECTIONAL DOOR: COSMOPOLITAN - MONUMENT **GUTTER:** MONUMENT PORCH: 133 AXON LINED CEILING; EXP. AGG. FASCIA: MONUMENT ALFRESCO: VERSILUX LINED CEILING; EXP. AGG. SPOUT: MONUMENT MAIN FLOOR COVERING: HYBRID ALUM. WINDOWS & DOORS: MONUMENT POOL SIDE: EXPOSED AGGREGATE: BEACHSIDE CLADDING: 133 AXON SMOOTH - JASPER **SIGN HERE** FACE BRICKS: **VAULT GREY** CHANGING THE COLOURS OR MATERIALS ABOVE MAY HAVE COST IMPLICATIONS. IF CONFLICT ARISE BETWEEN THIS TABLE & COCONSTRUCT SPECS & RENDER: MARBLE MIST / MONUMENT DATE: SELECTIONS, PLEASE ALWAYS ASK & CONFIRM. STONE:

NEW RESIDENCE LOT 10 (14B) LOMANDRA COURT, YARRAWONGA, VIC 3730

SCALE @ A3

CHK. BY:

DWG. BY: KAS

REG. NO.: DB-U 28382

DRAWING NO.

XX-XXXXX-WD00

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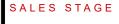
QUALITY CUSTOM HOME BUILDERS CONTACT: Shop 3/59-63 Belmore St., Yarrawonga, Vic 3730 Ph: 03 5743 3896 www.lekeal.com.au

PERSPECTIVE




Revision 1 - 20/10/2023

DRAWING STATUS






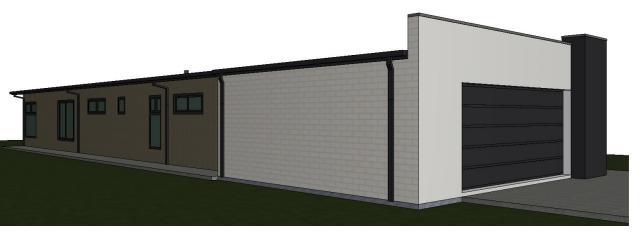





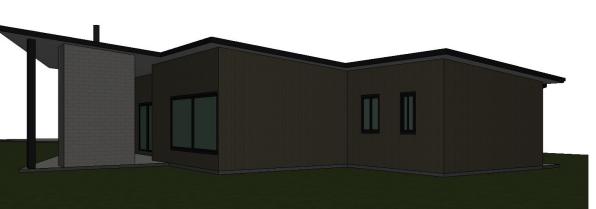

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DATE : _____

NEW RESIDENCE LOT 10 (14B) LOMANDRA COURT, YARRAWONGA, VIC 3730

SCALE 1:237.47, 1:349.03, 1:318.36, 1:224.31 CHK. BY: DWG. BY: - KAS

-

REG. NO.: DB-U 28382

DRAWING NO.

XX-XXXXX-WD00

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Lekeal

CONTACT:
Shop 3/59-63 Belmore St.,
Yarrawonga, Vic 3730 Ph: 03 5743 3896
www.lekeal.com.au

PERSPECTIVES

WALL & CEILING INSULATION:

- R2.0 WALL INSULATION TO EXTERNAL PERIMETER HOUSE WALL EXCEPT GARAGE EXTERNAL WALLS R4.1 CEILING INSULATION TO HOUSE


CONCRETE WAFFLE POD SLAB

EVAPORATIVE COOLING

DUCTED GAS HEATING





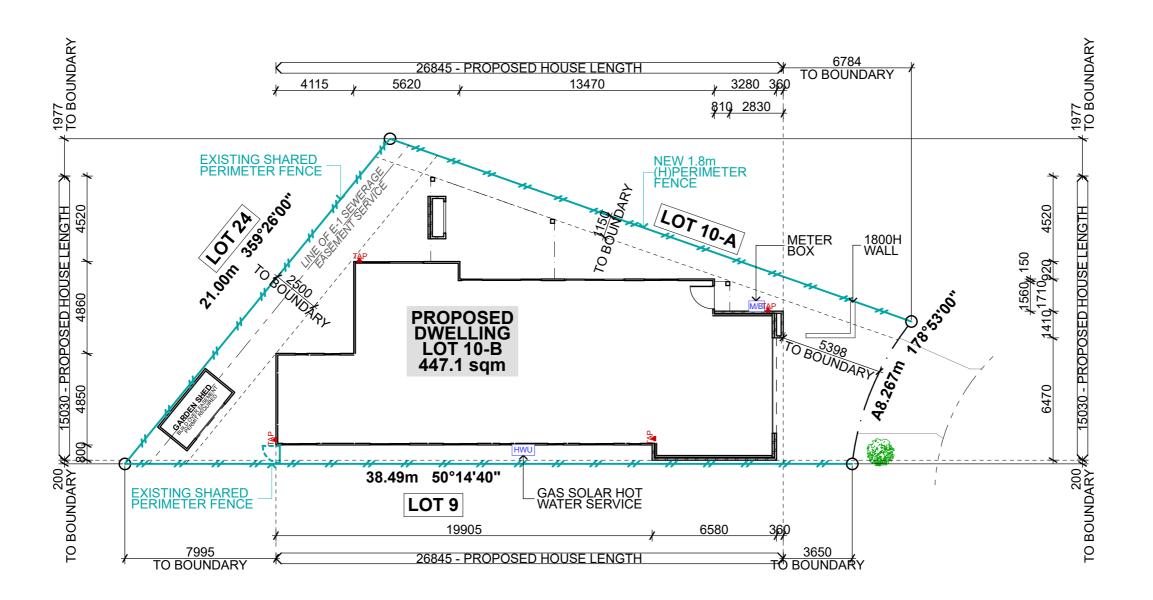

DRAWING STATUS

ISSUE DATE

Revision 1 - 20/10/2023

SALES STAGE

NOTES:

specified otherwise and are shown approximate only.

For details of all esements, refer to the

subdivision plan or certificate of title and othe information by the responsible authority. Refer to plan of subdivision of all bearings, distances and other site information.
All stormwater, waste water and sewer / septic details to the requirements of the responsible authority.

Soil Type: Wind Category: BAL Compliance: Outer Area: Slab Thickness: P (TBC) N2 (TBC) N/A NO 100mm (TBC)

NEW RESIDENCE LOT 10 (14B) LOMANDRA COURT, YARRAWONGA, VIC 3730

SCALE 1:200 @ A3

CHK. BY:

REG. NO.: DB-U 28382

DRAWING NO.

XX-XXXXX-WD01

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DWG. BY: KAS



QUALITY CUSTOM HOME BUILDERS CONTACT: Shop 3/59-63 Belmore St., Yarrawonga, Vic 3730 Ph: 03 5743 3896 www.lekeal.com.au

SET-OUT PLAN

SET-OUT PLAN SCALE 1:200

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WALL & CEILING INSULATION:

- R2.0 WALL INSULATION TO EXTERNAL PERIMETER HOUSE WALL EXCEPT GARAGE EXTERNAL WALLS R4.1 CEILING INSULATION TO HOUSE


CONCRETE WAFFLE POD SLAB

EVAPORATIVE COOLING

DUCTED GAS HEATING





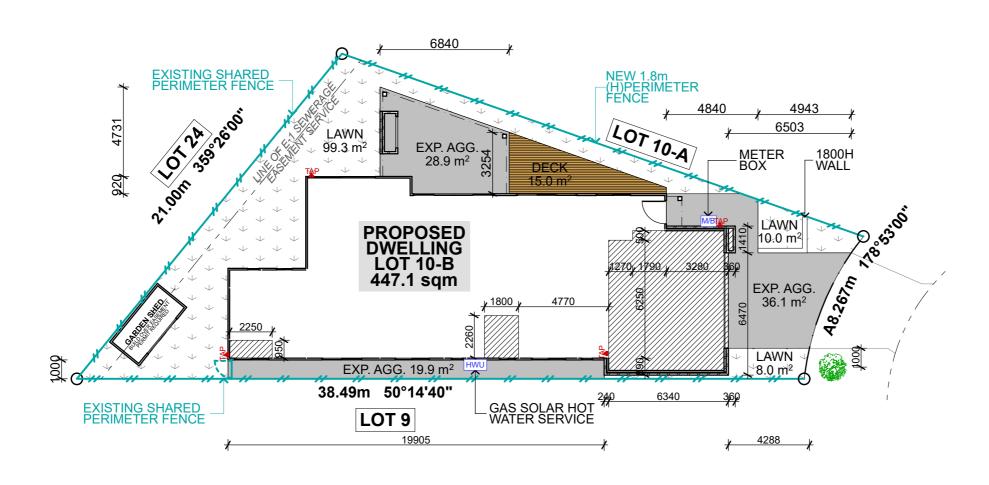

ISSUE DATE

Revision 1 - 20/10/2023

DRAWING STATUS

SALES STAGE

NOTES:

All site dimensions are in meters unless specified otherwise and are shown approximate only.

For details of all esements, refer to the

subdivision plan or certificate of title and othe information by the responsible authority. Refer to plan of subdivision of all bearings, distances and other site information.
All stormwater, waste water and sewer / septic details to the requirements of the

Soil Type: Wind Category: BAL Compliance: P (TBC) N2 (TBC) N/A NO 100mm (TBC) Outer Area: Slab Thickness:

PLANNING SCHEME REQUIREMENTS Garden Area Requirement: UP TO 500sqm=25%; 501-650sqm=30%; ABOVE 650sqm=35%

Site Area:

447.1 sqm Garden Area Required (25%): 111.78 sqm 114.93 sqm Garden Area Proposed:

Permeable Area Required (20%):89.42 sqm Permeable Area Proposed: 100.85 sqm

SITE COVERAGE REQUIREMENTS

Maximum site coverage allowable (60%): 268.26 sqm Maximum site coverage proposed (59.82%): 267.47 sqm

NEW RESIDENCE LOT 10 (14B) LOMANDRA

COURT, YARRAWONGA, VIC 3730

SCALE 1:200, 1:2 @ A3

CHK. BY: DWG. BY: KAS

REG. NO.: DB-U 28382

DRAWING NO.

XX-XXXXX-WD02



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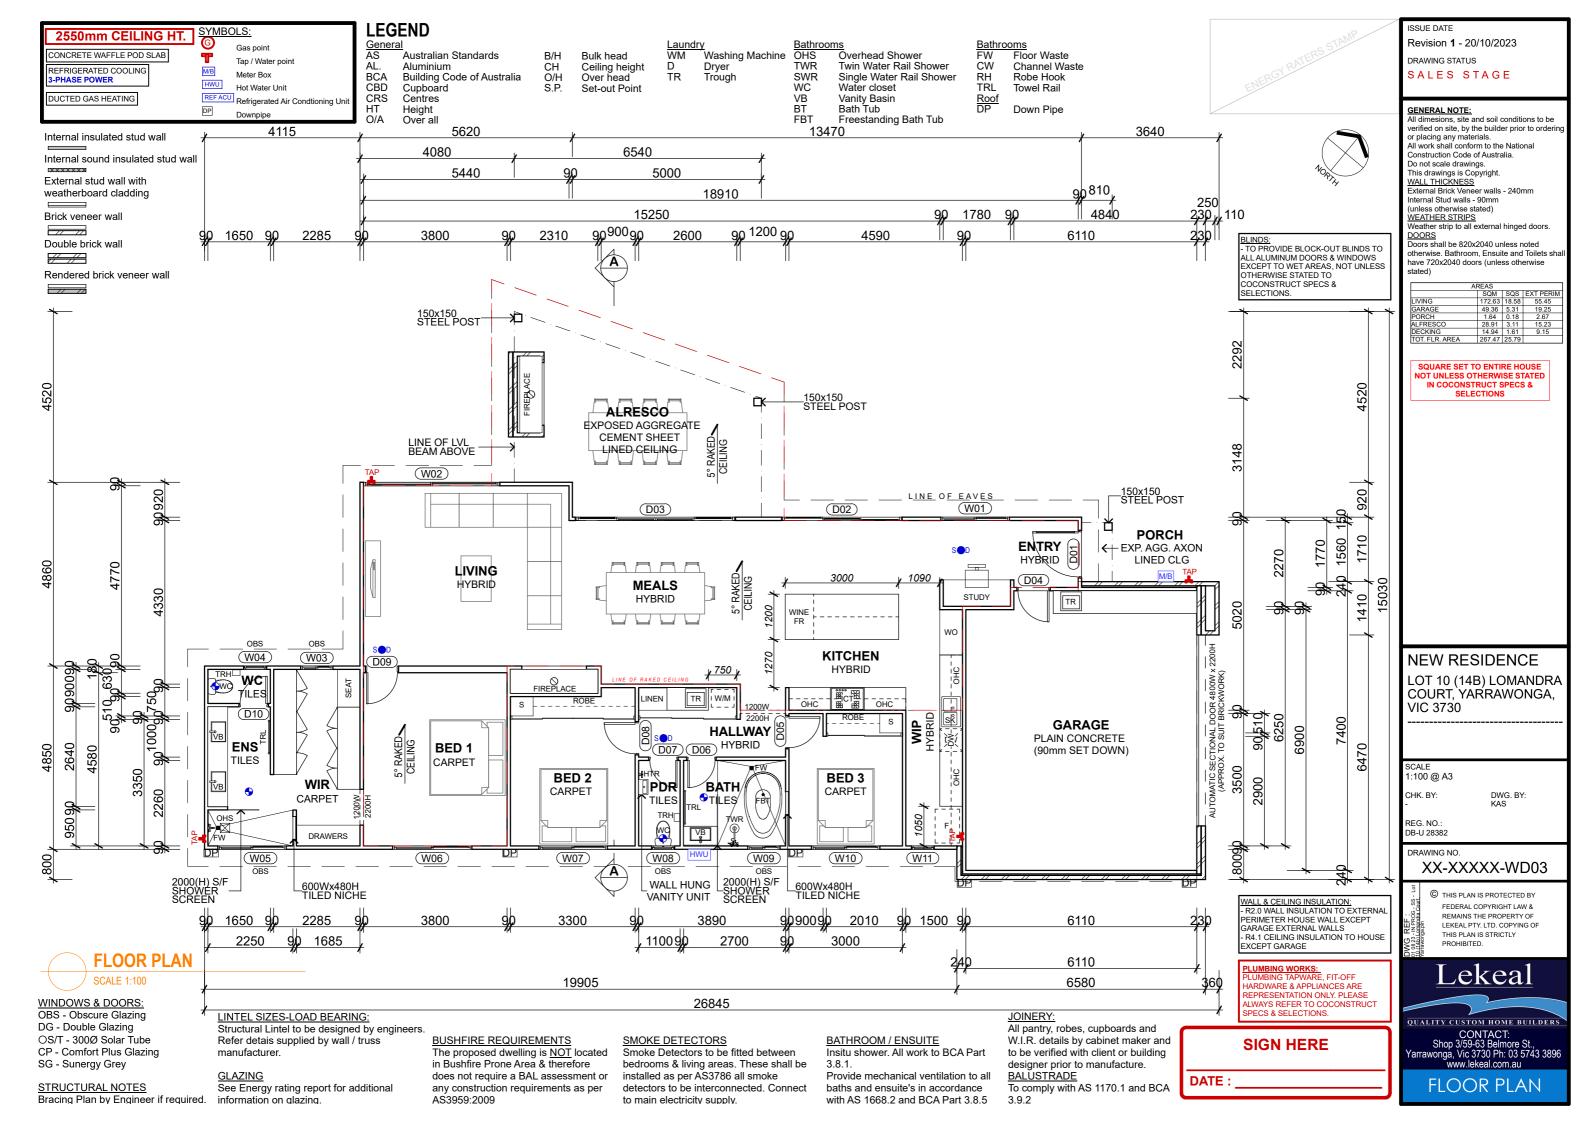







CONCRETE & LANDSCAPE PLAN SCALE 1:200

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SIGN HERE DATE:

ISSUE DATE

Revision 1 - 20/10/2023

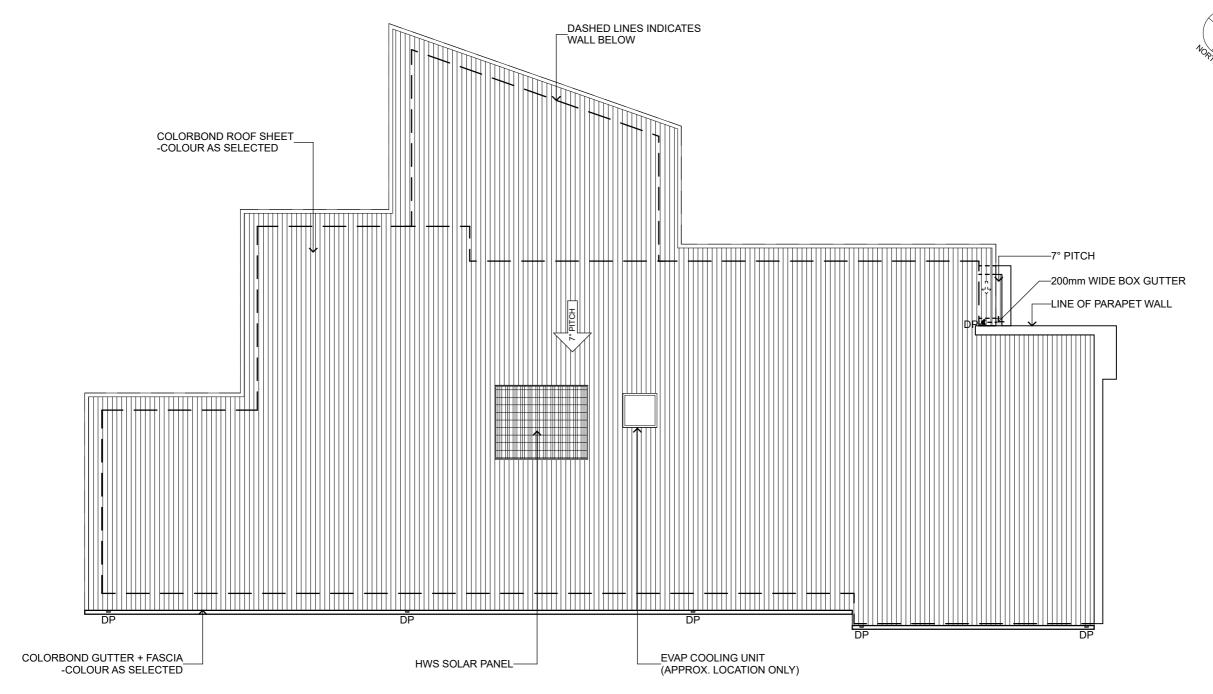DRAWING STATUS SALES STAGE

NOTES:

■DP Denotes colorbond downpipes. Downpipes at 12m cts. max. Locate a DP within 1.2m of any valley.

- - Dashed line denoted walls under.

Colourbond roofing installed to manufacturer's requirements and BCA regulations.

All roofing to comply with A3500. Make roof watertight.

Install sarking below all metal roofs. Extend sarking 50mm into gutters.

All box gutters to comply with SAA/SNZ 114

-Guidelines for Design of Eaves and Box Gutters

Turn throughs of all decking down 15mm at ends of all sheets.

- TO PROVIDE ROOF FLUE VENT FOR EXHAUST FANS & RANGE HOODS

- TO PROVIDE ROOF VENTILATIONS. VERIFY ROOF SUPPLIER FOR LOCATION

NEW RESIDENCE

LOT 10 (14B) LOMANDRA COURT, YARRAWONGA, VIC 3730

SCALE 1:100 @ A3

DWG. BY: KAS

REG. NO.: DB-U 28382

CHK. BY:

DRAWING NO.

XX-XXXXX-WD04

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ROOF PLAN

FLOOR COVERING AREA			
ROOM NAME FINISHES			
BATH	TILES		
BEDROOM 1	CARPET		
BEDROOM 2	CARPET		
BEDROOM 3	CARPET		
ENSUITE	TILES		
ENTRY	HYBRID		
GARAGE	PLAIN CONCRETE		
HALLWAY	HYBRID		
KITCHEN	HYBRID		
LAUNDRY	TILES		
LIVING	HYBRID		
MEALS	HYBRID		
PWD	TILES		
WC	TILES		
WIP	HYBRID		
WIR	CARPET		

NOTE: -TO ALL EXTERNAL FLOOR COVERINGS, REFER TO CONCRETE & LANDSCAPE PLAN (WD02 SHEET)









NOTES:

ISSUE DATE

FLOATING TIMBER FLOOR

Revision 1 - 20/10/2023 DRAWING STATUS SALES STAGE

PLAIN CONCRETE

FLOOR TILES

CARPET EXPOSED AGGREGATE

- ALL GROUTS TO BE CONFIRMED WITH THE TILER ON SITE.

-ALL WC IN SKIRTING TILES NOT UNLESS OTHERWISE STATED IN CPS.

WET AREA WALLS:
PROVIDE AN IMPERVIOUS
SUBSTRATE AND SELECT SURFACE
FINISH TO FLOORS WITHIN 1500MM
OF AN UNCLOSED SHOWER AND
SAME TO WALLS AT 1800MM ABOVE FLOORS AND 150MM ABOVE BATH, SINKS, BASIN AND TROUGH SPLASHBACKS AND THE LIKE. BCA PART 3.8.1

NEW RESIDENCE

LOT 10 (14B) LOMANDRA COURT, YARRAWONGA, VIC 3730

SCALE 1:100, 1:1.25 @ A3

CHK. BY:

REG. NO.: DB-U 28382

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XX-XXXXX-WD05

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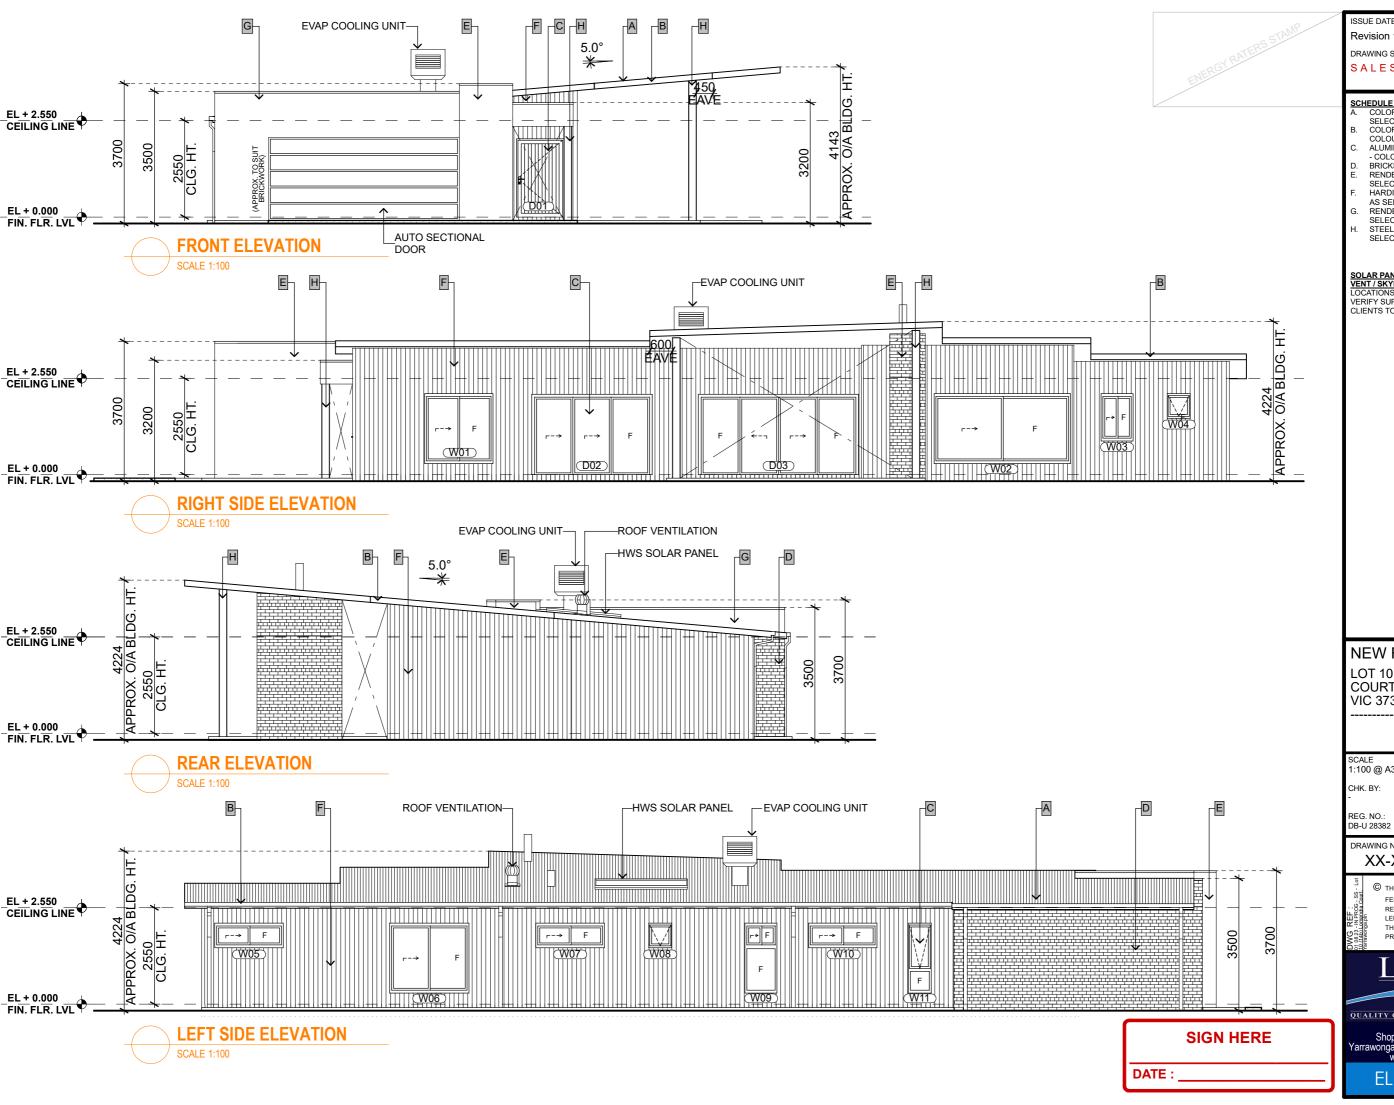
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Revision 1 - 20/10/2023

DRAWING STATUS

SALES STAGE

SCHEDULE OF FINISHES

A. COLORBOND ROOF - COLOUR AS SELECTED

B. COLORBOND FASCIA / GUTTER - COLOUR AS SELECTED

C. ALUMINUM P/C DOORS & WINDOWS

- COLOUR AS SELECTED BRICKS - AS SELECTED

RENDERED - COLOUR AS

SELECTED
HARDIES FINE TEXTURE - COLOUR

AS SELECTED RENDERED - COLOUR AS

SELECTED STEEL POST - COLOUR AS SELECTED

SOLAR PANEL / HWS PANEL / ROOF VENT / SKYLIGHT LOCATIONS ARE APPROXIMATE ONLY. VERIFY SUPPLIERS FOR LOCATIONS & CLIENTS TO CONFIRM ITS LOCATIONS.

NEW RESIDENCE

LOT 10 (14B) LOMANDRA COURT, YARRAWONGA, VIC 3730

SCALE 1:100 @ A3

DWG. BY: KAS

DRAWING NO.

XX-XXXXX-WD06

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Lekeal

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ELEVATIONS

PINE ROOF TRUSSES @900CRS. ENSUITE AND BATHROOM EXHAUST FANS TO BE VENTED TO OUTSIDE **WALL FRAMING:** PINE ROOF TRUSS SYSTEM DESIGNED BY MANUFACTURER-IN ACCORDANCE WITH BCA PART 3.8.5.0 **BUILDER TO USE** AND INSTALLED TO MANUFACTURER'S SPECIFICATION 90x35mm MGP10 STUDS AT 600mm CTS. ROOF: ARCHITRAVES, SKIRTINGS & DOORS AS SELECTED COLORBOND ROOFING PITCHED AT 22° WITH METAL TOP HATS @ 900mm CTS. 2/45x90mm MGP10 TOP PLATES TO LOAD BUILDER TO REFER TO TRUSS FABRICATOR DETAILS FOR LAYOUT AND CSR GYPROCK 10MM THICK TO WALLS AND CEILINGS ALL FIXED IN BEARING WALLS, 35x90 MGP10 BOTTOM ACCORDANCE WITH MANUFACTURER'S INSTRUCTIONS CORNICES AS PI ATF ALL ROOF FRAMING SHALL COMPLY WITH AS1684, PRE-FAB TIMBER ROOF SELECTED BY CLIENT JAMB STUDS - REFER TO TABLE. TRUSSES @ 900 CTS. BRACE WALLS WITH APPROVED SHEET CLAY BRICKS AS SELECTED WITH SELECTED MORTAR & JOINTING BRACES. ALL WALL FRAMING SHALL RFL AS SARKING TO UNDERSIDE OF ROOFING COMPLY WITH AS1684. NOGGINGS @ ALL BLOCKWORK IN ACCORDANCE WITH AS3700 AND BCA PART 3.3 DOUBLE SIDED RFL TO OUTER FACE OF EXTERNAL STUDS 1350mm CTS. MAX. MASONRY CONSTRUCTION PROPRIETARY WALL TIES IN BRICKWORK @ MAX 600CTRS IN EACH DIRECTION AND WITHIN 300MM OF DAMP PROOF COURSE TO EXTEND MIN 75MM ABOVE FLOOR LEVEL FIX TOP EDGE ARTICULATION JOINTS. ARTICULATION JOINTS IN BRICKWORK TO BCA OF DPC TO STUDS WITH CLOUTS OR PROPRIETARY FASTENERS PART 3.3 & BCA REFER TO ENGINEERS SLAB PLAN FOR LOCATIONS ALL TIMBER FRAMING IN ACCORDANCE WITH AS1684 AND BCA PART 3.4 FRAMING TO BE 90x35 & 90x45 MGP10 STUDS @ 450CRS WITH NOGGINGS AT MAX 1350MM LITEWEIGHT CLADDING AS SELECTED F17 LINTELS OVER ALL OPENINGS IN FRAMEWORK WHERE REQUIREDFRAME TO BE BRACED WITH PROPRIETARY METAL STRAP BRACING AND SHEET BRACING WHERE REQUIRED TO BCA PART 3.4 FRAMING AND AS1684 QUAD GUTTERING FIXED TO 190x33mm (NOMINAL) BARGE CAPPING HWS SOLAR PANEL **R4.1 CEILING INSULATION** -COLORBOND METAL FASCIAS: TO MATCH ROOF (CHECK ENERGY RATERS) (LOCATION TBC) FALL 1:400 TO SELECTED **DOWNPIPES** CONNECTION TO TRUSSES INSTALL SARKING UNDER -AS SPECIFIED BY ROOF ALL METAL ROOFS WITH **FABRICATOR CFILINGS** ROOF STRUCTURE TO ENGR'S DETAIL ROOF STRUCTURE TO ENGR'S DETAIL EL + 2.550 4224 O/A BLDG. **CEILING LINE** 450 10mm PLASTERBOARD LINING ON EAVE CEILING BATTENS AT 450mm CTS. 2550 CLG. HT 10mm PLASTERBOARD LINING **R0.9 SISALATION** PAPER В 0 BEDROOM 2 MEALS ALFRESCO œ EL + 0.000 FIN. FLR. LVL REBATE DEPTH TO BE NASONRY MODULES 0.2mm VAPOUR BARRIER. TAPE BARRIER -AROUND/WALL PLUMBING ALL AROUND PENETRATIONS. -50mm LEVELING SAND SOIL INVESTIGATION AND CLASSIFICATION IN ACCORDANCE WITH AS2870. FOOTINGS TO AS2870 FOUNDED AT MIN. DEPTH BELOW REFER TO PLAN BY OTHERS SURFACE AS RECOMMENDED BY ENGINEER. REFER TO ENGINEERS FOR FOOTING & SLAB DESIGN PLAN FOR ALL SLAB DETAILS PROVIDE TERMITE PROOFING UNDER SLAB AND VERANDAH AND ANY OTHER CRITICAL AREAS RECOGNISED AS BEING SUSCEPTIBLE TO PROVIDE A CONTINUOUS IMPERMEABLE BARRIER WITH THE INFESTATION APPROVED TERMITE PROOFING METHOD TO BE CARRIED SARKING / HOUSE WRAP / REFLECTIVE FOIL. PAY PARTICULAR OUT BY CONTRACTOR IN ACCORDANCE WITH BCA AND AS 3660. ATTENTION TO: 1. TAPING ALL JOINS AND AROUND PENETRATIONS (SUCH AS PLUMBING SERVICES); 2. ENSURING THAT THE MATERIAL COVERS THE GAP BETWEEN STUDS AND DOOR & WINDOW FRAMES. IF FLASHING IS ATTACHED TO WINDOW FRAME, FLASHING SHOULD BE TAPED OVER SARKING / HOUSE WRAP / REFLECTED FOIL. **SIGN HERE**

SECTION
SCALE 1:50

SIGN HERE

DATE:

NEW RESIDENCE

LOT 10 (14B) LOMANDRA COURT, YARRAWONGA, VIC 3730

SCALE 1:50 @ A3 CHK. BY:

ISSUE DATE

DRAWING STATUS

Revision 1 - 20/10/2023

SALES STAGE

DWG. BY

REG. NO.: DB-U 28382

DRAWING NO. XX-XXXXX-WD07

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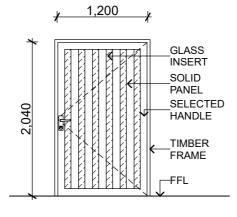
Lekeal


QUALITY CUSTOM HOME BUILDERS

CONTACT:
Shop 3/59-63 Belmore St.,
Yarrawonga, Vic 3730 Ph: 03 5743 3896
www.lekeal.com.au

SECTION

DOOR SCHEDULE				
DOOR NO.	DOOR NO. SIZE TY			
D01	1200×2040	Н		
D02	3140×2100	Α		
D03	4190×2100	Α		
D04	820×2040	Н		
D05	820×2040	Н		
D06	720×2040	Н		
D07	720×2040	H*		
D08	820×2040	Н		
D09	820×2040	Н		
D10	720×2040	H*		



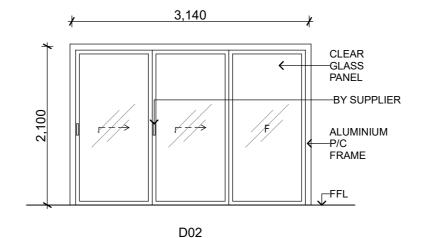

NOTES:

HINGED DOOR CAVITY SLIDER REMOVABLE HINGES ALUMINUM P/C GLAZED DOOR 2H 2CS BD BI

Revision 1 - 20/10/2023 DRAWING STATUS

SALES STAGE

PAIR HINGED DOORS PAIR CAVITY SLIDERS BARN DOOR

WINDOWS & DOORS:

OBS Obscure Glazing
DG Double Glazing
CP Comfort Plus Glazing DG CP SG

THESE DRAWINGS ARE FOR ILLUSTRATIVE PURPOSES ONLY. REFER TO SPECS FOR THE ACTUAL

NEW RESIDENCE LOT 10 (14B) LOMANDRA COURT, YARRAWONGA,

DWG. BY: KAS

XX-XXXXX-WD08

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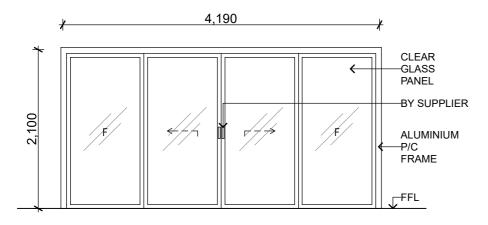
VIC 3730


SCALE 1:1 @ A3 CHK. BY:


REG. NO.: DB-U 28382 DRAWING NO.


D01 **ENTRY** TIMBER EXTERNAL SOLID PANEL HINGED DOOR

KITCHEN THRU DECK ALUMINIUM POWDER COATED SLIDING DOOR W/ FIXED PANEL ALUMINIUM SLIDING DOOR



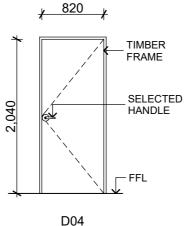

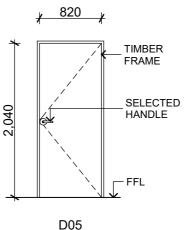

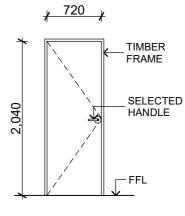



D06 **BATH** TIMBER INTERNAL **HOLLOW CORE** HINGED DOOR


D03 **MEALS ALUMINIUM POWDER COATED** SLIDING DOOR W/ FIXED PANEL ALUMINIUM SLIDING DOOR


GARAGE TIMBER INTERNAL **HOLLOW CORE** HINGED DOOR

BEDROOM 3 TIMBER INTERNAL **HOLLOW CORE** HINGED DOOR

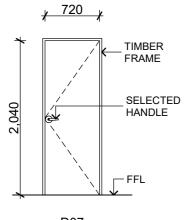


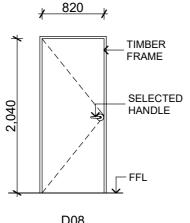

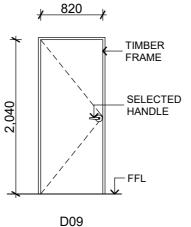

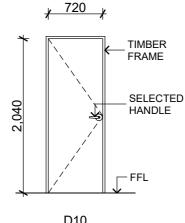

D10 WC TIMBER INTERNAL HOLLOW CORE

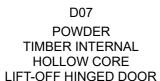

D08 BEDROOM 2 TIMBER INTERNAL HOLLOW CORE HINGED DOOR

BEDROOM 1 TIMBER INTERNAL **HOLLOW CORE** HINGED DOOR

LIFT-OFF HINGED DOOR

SIGN HERE







NOTES:


Revision 1 - 20/10/2023 DRAWING STATUS SALES STAGE

- CONFIRM ALL SIZES PRIOR TO ORDERING AS PER SITE MEASUREMENTS


WINDOWS & DOORS:

OBS Obscure Glazing
DG Double Glazing
CP Comfort Plus Glaz
SG Sunergy Grey


Comfort Plus Glazing

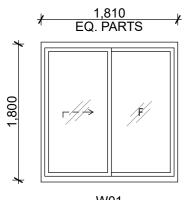




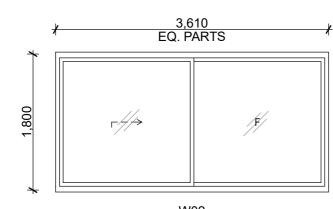


W02 LIVING ALUMINIUM POWDER COATED SLIDING W/ FIXED PANEL WINDOW

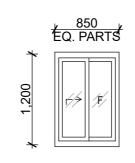


W03 WIR ALUMINIUM POWDER COATED SLIDING W/ FIXED PANEL WINDOW FROSTED GLASS

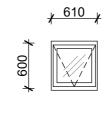


W04 WC ALUMINIUM POWDER COATED **AWNING WINDOW** FROSTED GLASS

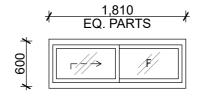

W05 **ENSUITE** ALUMINIUM POWDER COATED SLIDING W/ FIXED PANEL WINDOW FROSTED GLASS

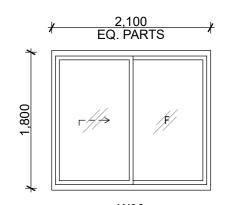


W06 BEDROOM 1 ALUMINIUM POWDER COATED SLIDING W/ FIXED PANEL WINDOW

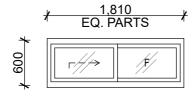


W07 BEDROOM 2 ALUMINIUM POWDER COATED SLIDING W/ FIXED PANEL WINDOW



80W **POWDER** ALUMINIUM POWDER COATED **AWNING WINDOW** FROSTED GLASS

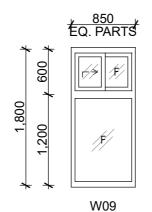

BATH ALUMINIUM POWDER COATED SLIDING WINDOW W/ FIXED TRANSOM FROSTED GLASS

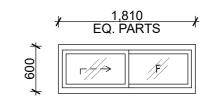

W10 BEDROOM 3 ALUMINIUM POWDER COATED SLIDING W/ FIXED PANEL WINDOW

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NEW RESIDENCE LOT 10 (14B) LOMANDRA COURT, YARRAWONGA, VIC 3730

DWG. BY: KAS

SCALE 1:1 @ A3

CHK. BY:

REG. NO.: DB-U 28382

DRAWING NO.

XX-XXXXX-WD09

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WINDOW SCHEDULE SCALE 1:1

> **SIGN HERE** DATE:

Internal power outlets to be located 300mm above the floor (or becnh top) unless it serves a specific appliance such as a refrigerator or dishwasher where the position shall be appropriate for the equipment.

External & garage power outlets to be located 1000mm above floor. Power for garage doors to be located next to garage door motor. Powerpoints & light control switches shall be located next to garage door motor

Light control points shall be located 1000mm from the floor.

All light fittings (expect where noted otherwise) shall be supplied and installed by the builder.

TV aerial to be supplied and installed by owner after completion of contract.

Provide power to all appliances that require power such as heaters, coolers and stoves.

All work to comply with AS3000 and the Supply Authorities requirements. Telephone connection fees by owner. Meter box to be metal.


Electrician to liase with Client to check if NBN & associated data point connection is required to future proof house.

Smoke detectors to be interconnected as per regulation 3.7.2.2 (d) of the NCC.

Flow rates & discharge of exhaust systems to be in accordance with NCC 2019 VOlume Two, Clause 3.8.7.3.

Building insulation abutting or is within 100mm horizontally of the luminaire must meet the following reuirements: Be of a type that can withstand a 30 second needle flame test carried out in accordance with AS/NZS 60695.11.5 with a flame applied to all surfaces of the sample. Insulation types which should ne used this fitting are glass wool (Pink Batts) & polyester.

IMPORTANT NOTE: BUilder must NOT install loose fill insulation, such as wool or macerated paper. Fixture Driver or COntrol Gear must be mounted <u>above</u> any insulation covering the fixture.

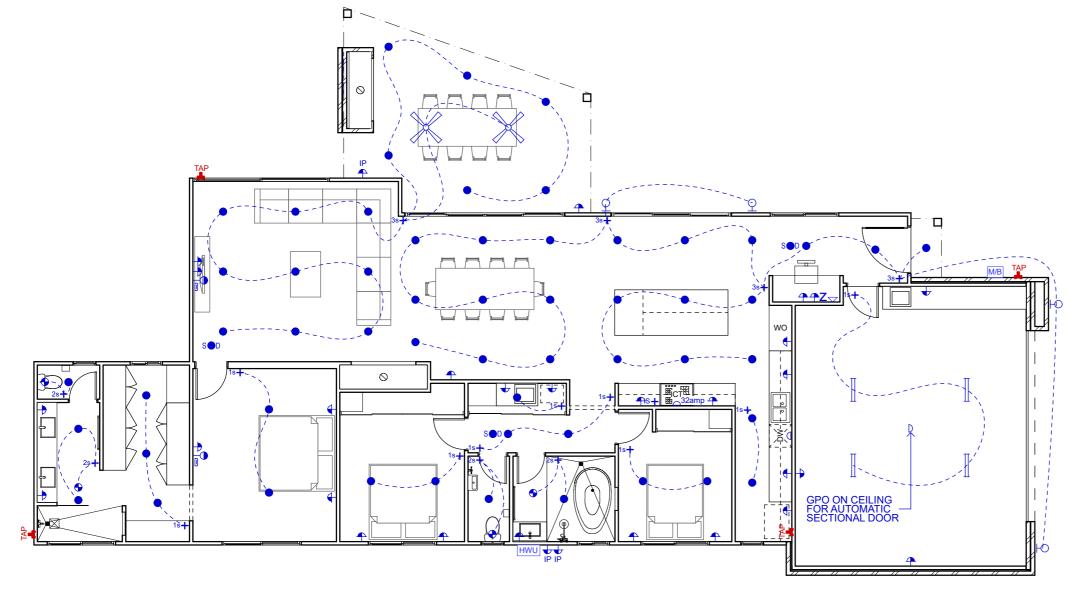

ARTIFICIAL LIGHTING TO COMPLY WITH N.C.C.3.12.5.5			
WATT RATIO	ZONE	AREA	MAX. WATTS
HOUSE AREA 5W/m²	LIVING	172.63m²	863.15 W
COVERED	PORCH	1.64m²	6.56 W
AREA 4W/m²	ALFRESCO	28.91m ²	115.64 W
GARAGE AREA 3W/m²	GARAGE	49.36m²	148.08 W
	TOTAL	252.54m ²	1133.43 W



POOL & PUMP SHED:
- PROVISION OF POWER & PLUMBING
- BACKWASH & WATER LEVELLER CONNECTION TO BE INCLUDED



LEGEND

		"I'H
	POWER	QTY.
٥	SINGLE GPO	1
32amp	SINGLE GPO - 32AMP	1
4	DOUBLE GPO	27
□P	SINGLE GPO IP RATED	-
4 _{IP}	DOUBLE GPO IP RATED	3
O —	TV POINT	2
M/B	METER BOX	1
Z	TELEPHONE POINT	1
HWU	HOT WATER UNIT	1
#	USB GPO	-
	FLOOR MOUNTED DOUBLE GPO	-
\triangleright	DATA POINT	1
##-	TV AERIAL ANTENNA	1
	HDMI	2
	HDMI	

	<u>LIGHTING</u>	QTY.
+ _{1s}	1-GANG SWITCH	9
+ _{2s}	2-GANG SWITCH	4
+ _{3s}	3-GANG SWITCH	4
+ _D	DIMMER SWITCH	-
+ _{IS}	ISOLATION SWITCH	1
-2-	TWO-WAY LIGHT SWITCHING	-
3- ′	THREE-WAY LIGHT SWITCHING	-
	ELECTRICAL WIRING	-
오	WALL MOUNT LIGHT	4
•	DOWNLIGHTS - LED	56
8	DOWNLIGHT W/ SENSOR	-
	FLUORESCENT LIGHT	4
+	EXHAUST FAN	4
88	IXL TASTIC	-
X	FAN ONLY	2
X	FAN / LIGHT	-
SOD	SMOKE DETECTOR	2
	LED STRIP LIGHT	-
Ф о/s	PENDANT FEATURE LIGHT	-
•	SPOTLIGHT W/ SENSOR	-
Q U/D	UP-DOWN WALL LAMP LIGHT	-
\$2	DOUBLE ENDED SPOTLIGHT	-
*	CHANDELIER	-
	ILLUME	-

	<u>OTHERS</u>		
G	GAS POINT	-	
T	TAP	4	

SIGN HERE

DATE:

ISSUE DATE

Revision 1 - 20/10/2023

DRAWING STATUS SALES STAGE

NEW RESIDENCE LOT 10 (14B) LOMANDRA COURT, YARRAWONGA, VIC 3730

SCALE 1:100 @ A3 CHK. BY:

DWG. BY: KAS

REG. NO.: DB-U 28382

DRAWING NO. XX-XXXXX-WD10

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ELECTRICAL PLAN




Revision 1 - 20/10/2023


DRAWING STATUS

SALES STAGE

NOTES:

- SUBJECT TO CHANGE AFTER ON SITE MEASURE BY OUR SHELVING & ROBE CONTRACTOR

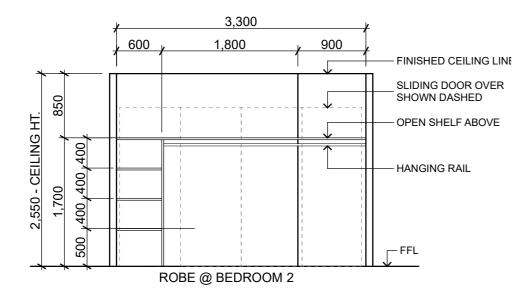

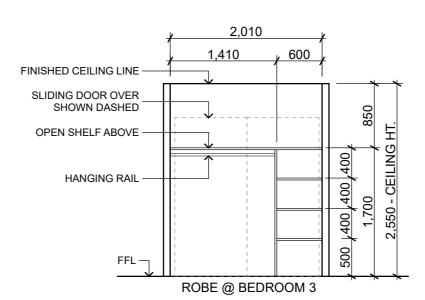

THESE DRAWINGS ARE FOR ILLUSTRATIVE PURPOSES ONLY

NEW RESIDENCE LOT 10 (14B) LOMANDRA COURT, YARRAWONGA, VIC 3730

SCALE 1:50 @ A3

CHK. BY: DWG. BY: KAS

REG. NO.: DB-U 28382

DRAWING NO.

XX-XXXXX-WD11

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Lekeal

QUALITY CUSTOM HOME BUILDERS CONTACT: Shop 3/59-63 Belmore St., Yarrawonga, Vic 3730 Ph: 03 5743 3896 www.lekeal.com.au

SHELVING DETAILS

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GENERAL NOTES



ISSUE DATE

Revision 1 - 20/10/2023

DRAWING STATUS
SALES STAGE

ENERGY RATING NOTES

New Work

The Builder shall refer to the Energy Rating Report for details.

All glazing shall be as per the Energy Rating Report.
All windows shall be fitted with the seals on all 4 sides.

All exhaust fans shall be self closing.

All external swing doors & internal doors in house / garage walls shall be fitted with Raven compressible rubber door seals at the top and sides. At the bottom of all swing doos, install a Raven flap seal.

All roof lights to be sealed with a weatherproof seal.

Refer to the Section on the Plans for details of wall insuation and ceiling insulation

For Energy rating purposes, we have assumed a 225mm / 300mm deep minimum waffle pod will be used. If the slab is a raft slab then the Energy rating will need to be modified.

OWNERS NOTES

Owners should be maintain their buildings in accordance with the CSIROs Home Owners Maintenance manual.

Clay soils will swell, and shrink with variations in moisture content. This movement may cause damage to the building.

In order to minimise the damage, we recommend the following precautions be taken -

- 1) Provide adequate site drainage to ensure water will not pond against or near the building.
- 2) Grade the site within 2 meters of the building, away from the building, to ensure that no water ponds near the building.
- 3) Maintain sewage and stormwater systems to ensure no leakage occur. If they occur, repair them promptly.

 4) Trees and shrubs should not be planted or allowed to exist, closer than
- 4) Trees and shrubs should not be planted or allowed to exist, closer than 0.75 times their mature height.

Avoid establishing garden beds next to the building. Gardens and lawns should be watered adequately but not excessively. Uniform consistent watering can be important to prevent damage to the foundations during dry spells or droughts.



BUILDERS NOTES

STANDARDS

The Builder shall ensure the building complies withthe following Regulations & Standards

Building Code of Australia

AS 1562 Roofing

AS 1288 Glazing Code

AS 2870 Slabs and Footings AS 3500 Plumbing Code

AS 3660 Termite Code

AS 3000 Terrifile Code
AS 3000 Electrical

AS 1684 Timber Framing

AS 3730 Waterproofing Code

and all other standards nominated in the NCC

SITE LEVELS

The Builder shall ensure the building is built at a minimum of 450mm above any adjoining ground level.

The Builder shall grade the soil away from the building at a rate of 50mm for every meter for at least 2 meters to ensure any surface water will not pond against the building.

If there is a Flood Level nominated on the site, the building shall be built to the minimum floor level nominated by the Building Surveyor.

MASONRY

Incorporate Control Joints (or full height openings) in all masonry walls at a maximum of 4.5 meters cts. Locate additional joints inmasonry directly over junctions in footings which are different types, eg. at House / Garage

TERMITE PROTECTION

Treat building for termites as per AS 3660.1. Use termite resistant T2 framing (walls, trusses & all primary building elements) throughout proposed works.

Install Homeguard Blue termite collars around all plumbing penetrations thru slab.

TIMBER EXPOSED TO WEATHER

All timber exposed to weather, but not in ground, shall be to H3 classification.

All timber in ground to be H5 classication.

GLAZING - BATHROOMS, ENSUITES & SPA ROOMS

All windows within 2000mm of the floor shall have Safety glazing as per AS 1288 - 2006 SEC 5-5.8

FLOOR TILES

MInor movement shall inevitably occur in most floors. In order to minimise any damage to floor tiles as a result of floor cracking / movement a flexible adhesive shall be used.

DOORS

Door sizes shall be as per floorplan unless noted otherwise.
Bathroom, Ensuites & Toilets shall have door sizes as per floor plan.
Toilet cubicle doors shall be fitted with removable hinges.

SMOKE DETECTORS

Smoke detectors are denoted S D on the plan. These shall be installed as per AS 3786. Where more than 1 detector is installed, they shall be interconnected electrically. Connect to main electricity supply.

BUILDERS NOTES (cont'd)

ASBESTOS

If any possible Asbestos material are found, they should be checked and tested. If confirmed, it must be removed by a licensed contractor in accordance with Worksafe quidelines.

DRAINS

Piping trenches running parallel with the Building should be located at an offset from the footing equal to the depth.

STAIR DETAILS (if required)

Riser Height - Min. 115mm, Max. 190mm Tread Going - Min. 250mm, Max. 355mm

Minimum Vertical Clearance - 2000mm

Install 1x handrail 900mm above nosing for dwellings

BALUSTRADES

(applicable for landings, Balconies & Verandahs 1000mm minimum above the ground level)

<u>HEIGHT</u>

865mm minimum above stair tread nosings 1000mm maximum above finished floor level

OPENING

Constructed so a 125mm sphere cannot pass through.

NOTES FOR ENGINEERS

The Engineer engaged to carry out the design of the slabs and footings shalls design the system in accordance with AS 2870, AS 3600, NCC, the Soil Test and all other site conditions such as cut/fill which may exist on the site.

The Engineer shall take into consideration trees and underground pipes which exist or may exist in the future.

The Engineer shall collect information on all the piping systems, sewer mains, plumbers sewer drainage pipes, stormwater pipes, etc., slab heating (electric / hydronic if applicable) and design his slab / footings accordingly.

The Engineer shall liase directly with the Sewer Authority, plumber, client and builder to obtain the above information.

The Engineer engaged to carry out the design of the slabs / subfloor shall take full responsibility for the above.

Lekeal Pty. Ltd does not accept any responsibilty for the Engineer's work.

DESIGN WORK BY ENGINEER

Soil Test

Footing Design

Misc. Steel Beams shown on Plans

Column to support steel beams

Other items needing Engineering Design

Upper Floor floor joist (if applicable)

Bracing details

THIS SITE - SOME OF THE ISSUES

Engineer to note

Sewer mains and plumbers sewer drainage pipes near footings

Isolated patches of fill

Extensive fill on site Cut / fill site

Large tree stump holes under building

Sloping Site

BRACING PLAN

Bracing Plan by Engineer if required

These are only some of the issues to be considered in the footing design. This is not a complete list of issues. The Engineer shall investigate all the issues which may effect the design and ensure that the design is appropriate and structurally sound.

The Engineers shal forward a copy of Plans, Soil Tests, Computations etc. to Lekeal Pty. Ltd.

NEW RESIDENCE LOT 10 (14B) LOMANDRA

COURT, YARRAWONGA, VIC 3730

SCALE @ A3

CHK. BY:

DWG. BY

DB-U 28382

REG. NO.:

XX-XXXXX-WD12

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GENERAL NOTES

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BUILDING SPECIFICATIONS - GENERAL

REFER TO BUILDERS SPECIFICATION FOR CONTRACT DETAILS AND INCLUSION:

GENERAL CLAUSES

All work shall comply with the Buildign Code of Australia, State Government Regulations and any relevant local Government bylaws applying to the work. All work shall compy to the relevant standards for that particular trade.

Owner - Shall mean the owner of the building, proprietor or client.

The word builder shall also mean contractor.

<u>Making Good</u> - The builder shall be responsible for any damage to adjoining roads, pavement or properties. The builder shall make good any damage at his cost.

Temporary services - The builder shall provide necessary temporary services such as electricity, water and sanitary accomodation.

<u>Drawings</u> - The builder shall keep on site, in good order 1x set of plans and specifications.

<u>Materials</u> - All materials shall be new and comply with the relevant sections of the Australian Standards.

<u>Notices and Fees</u> - The builder shall pay for all fees and notices (except planning permit fees) for the work to be done.

<u>Clean Up</u> - The builder shall be responsible for cleaning up the building site of any excess soil, unused materials, etc. prior to the handover.

<u>Site</u> - The owner shall be responsible for clearly identifying the site, with a licensed surveyor if necessary. The builder shall locate the house within the identified site as per plans.

Allowances - The builder shall allow in his price, the prime cost allowances nominated. Where items are 'Supply only' the builder shall allow in the contract sum for the labour cost to install the components. Should the expenditure exceed the allowance, the owner shall pay the builder the extra amount plus 10% of the extra amount. Should the expenditure be less than the allowance, the builder shall credit the owner the difference.

EXCAVATOR

The owner at his expense, shall clear the site of any obstructions, likely to interfere with the building works, prior to the commencement of the building.

<u>Excavation</u> - The builder shall excavate fo footings, etc. as per the Engineer's plans, soil report and Architectural plans. The builder shall excavate for stowm water and sewer pipes required to service the building. All excavations for piped shall be back filled with approved material.

<u>Surplus Materials</u> - The builder shall remove all surplus material from the site at his cost. The builder may leave surplus material on the site if directed by the owner.

<u>Inspections</u> - The builder shall organise appropriate inspections of the founding material below the footings by the building surveyor or engineer.

CONCRETOR

Inspections - The builder shall organise appropriate inspections of the slab reinforcing, prior to pouring concrete, by the building Survey or Engineer.

<u>Concrete</u> - All concrete shall have minimum strength of 25Mpa at 28 Days. It shall have a maximum slump of 80mm.

Reinforcement - All reinforcement shall be in accordance with Australian Standards 1302, 1303, 1304 & 1480. All slab mesh shall have 25 cover to the top.

<u>Standard</u> - All work shall be carried out to ensure complaince with Australian Standard 2870 and to the Engineer's drawings.

<u>Footings and verandah posts</u> - See Engineers Plan

Finish - The finish shall be steel trowelled, approriate for the final finish

<u>Verandah and Foothpaths</u> - Unless noted otherwise on the plans, use 100mm thick slabs with SL72 mesh in the top for non-filled areas. See engineers drawings for slabs overfilll. Install tooled control joints at 1.2 meter cts. for the length of the slab. Fall verandahs and footpaths to create cross fall.

Garage slab - See plans

Moisture barrier - All slabs shall be protected from moisture penetration from below with a 0.2mm plastic vapour barrier. Lap and tape all vapour barriers. Tape barrier around plumbing penetrations to eliminate any chance of moisture penetration.

MASONRY

Set-out - All masonry shall be set out with a gauge rod to enusre every course is horizontal. The masonry shall be laid with a stretcher bond. All perpends in every 2nd course will line up vertically.

Standard - All masonry shall comply with Australian Standard 3700.

Sills - All sills will be brick on edge, set 30° to the horizontal and shall overhand the wall by 20mm

<u>Mortar</u> - The colour and type of the mortar shall be nominated by the owner

<u>Lintels</u> - All steel Lintels supporting Masonry shall be galvanised in accordance with Australian Standard 3700. Lintels shall have an end bearing of 200mm.

Door sills - All door sills shall be brcik on edge.

Damp proof courses - All masonry shall have an approved damp proof course to prevent the movement of damp vertically up brickwork. The builder may use an approved chemical damp proof course mixed and used as per the manufacturer's recommendations or embossed opaque plythene film a minimum of 0.25mm thick. Wall ties - All wall ties shall be installed as per Australian Standard 2699 - See plans.

<u>Cleaning</u> - Point up all flashings, pipe penetrations, etc. Clean brickwork with spirits of slats diluted to a maximum of 1 in 10. Wash down Masonry with water after cleaning

CARPENTRY

All timber used shall comply with Australian Standards 1684 and 1720

<u>Frames</u> - See plans for stud and plate sizes. Install studs at all jambs as per Australian Standard 1684. Secure bottom plate to slab with concrete nails at 600 cts. All walls shall be erected plumb, square and true in line. All studs shall be straightened, if require prior to lining, See Australian Standards 1684 for sheet bracing or metal angle wall braces.

Shower recess - Check wall to suit shower base nominated on

Bath - Check wall to suit bath. Make water tight.

Eave and verandah lining - Where shown on the drawings, install 4.5mm cement sheet lining, joined with PVC cover straps. Fix sheets to 90x35mm MGP 10 pine at 450mm cts. or as per plans. All tiled roofs to have lined verandahs. All eaves are to be lined. Roof trusses - Supply and install prefabricated roof trusses as per manufacturer's design. Supply and install tie downs, girder truss, connector plates strictly as per manufacturer's specifications. Architraves and skirtings - To be selected by owner. Supply and install a skirting board at all floor / wall junctions. Supply and install an architrave around every door and window. Neatly mitre achitrave's at corner.

<u>Door frames</u> - Supply and install one ex 150x38mm H.W. or meranto solid door frame around the perimeter of every external door. Door stops to be 50x10mm (nominal). Internally supply and install a 110x25 H.W. door frame with a 30x10 door stop. Secure frames to studs. Fix frames level and true.

Cavity doors - Supply and install built-in robes where shown on plan. Install 1x Melamine shelf 1700mm from floor and 1x chrome hanging rail suspended from shelf for each robe. At one side of robe supply and install 600mm wide adjustable shelving. Supply and install Melamine shelves normally spaced at 400cts. Line the inside of robes with plasterboard as per remainder of house. Paint inside of cupboards. Fix door jambs to perimeter of door openings to robes together with architraves mitred at corners.

TIMBER EXPOSED TO WEATHER

All timber exposed to weather, but not in ground, shall be to H3 classification.

All timber in ground to be H5 classification.

<u>Linen press</u> - Supply and install linen press where shown on plans. Install melamine shelves at 400mm cts. (nominal)

Broom cupboard - Supply and isntall a broom cupboard with 1x melamine shelf 1700mm from floor

<u>Joiner</u> - Supply and install kitchen cupboards and other joinery wher shown on plan. Finishes as per plans. Install a 50mm deep x 100mm high kick recess at base. Joinery to be manufactured by an approved cabinet maker. Install a bulkhead over overhead cupboard. See plans for number of drawers. In top cutlery drawer install a plastic cutlery tray. All cupboard doors to have concealed adjustable hinges.

Vanity Units - unless noted otherwise on plans, all vanity units to be fabricated by a joiner.

ROOFING

The builder shall supply and install roofing as per plans in accordance with the relevant Australian Standard. All ridge & hip tiles and valley gutters shall match the roof colour. Where sheet roofing is nominated on the plans, the roofing shall be installed strictly as per the manufacturer's recommendations. All sheet roofing to be Custom Orb unless noted otherwise, in one length. Water Tight - It is reponsibility of the builder to ensure the building is completely water tight.

Gutters - Supply and install gutters as per plan. Fall gutters 1:400 to downpipes. All gutter joins to the sealed. Install downpipes to pops from gutters. Attached gutters to walls at 900 cts. with straps fixed to wall. All flashings shall be either lead flashings or 0.6mm metal.

PLUMBING

All plumbing to be carried out by the licesed plumber in accordance with AS 3500 and the relevant plumbing regualtions. Water supply shall be extended from the front of the site of the house. If a tapping is required from the mains, it shall be done at the owners expense. The builder shall assume the point of supply for water is within 15meter from the house. If it is greater than 15meters, the owner shall bear the additional cost. For houses without access to a water main the builder shall allow for the 15meter of line as above. The costs of pumps and tanks, etc. unless noted otherwise, shall be borne by the owner. Install a stop cock to enable the water supply to the house to be controlled. Garden Taps - The builder shall allow for 4x garden taps for the house, which will be attached to the house unless noted otherwise. 2x tap will be at the front and 2x will be positioned at the rear of the house. The owner shall approve the exact positions prior to installation.

Hot Water Service - If electric hot water services is installed, the builder shall install a 315 litre Thermann or approved similar. Where a natural gas hot water service is installed, the builder shall install a 26L Thermann continuous flow / Rinnai unit or similar approved. Where a solar hot water service is installed, the builder shall install a 315 Thermann / 270 L or 320 L Rinnai solar gas boosted unit or approved similar. Install a HWS strictly as per manufacturer's recommendations. All hot water services shall be mains pressure

Taps - To be nominated by owner

Sanitary Plumbing - All sewerage work shall be carried out by a registered plumber approved by the local authority with control over the work. Any fees and charges associated with the work shall be paid for by the builder. In areas which are not sewered, install a septic system to the approval of the local authority which has control over the work. See Inclusions Sheet

Drainage - The plumber shall install stormwater pipes to connect to all the downpipes and discharge point approved by the local authority having control over drainage matters. All pipes shall be 90ø PVC falling in 1 in 400 meters minimum to the point of discharge. Provide a minimum of 200mm cover at high end. Seal all pipes with appropriate glue.

Sloping Sites - On all sites on which the land falls to the building, the builder shall install agricultural pipes embedded in 12mm crushed rock, & earth surface drains which ensure surface water & sub-surface water will not pond against or near the building.

Gas Piping - All gas pipes and fittings shall be installed as per the Authorities regulations. with control over the works requirements. The work shall be carried out by a registered gas fitter. The builder shall extend the gas line from the appliances nominated as gas appliances (See Inclusions Sheet), to the source of supply. All gas pipes shall be appropriately sized to suit the requirements of the appliances being served, and the requirements of the gas regulations.

ELECTRICAL

All work shall be carried out by a registered electrician in accordance AS 3000 & with the authority with jurisdiction over the work. The electrician shall give appropriate notices, pay fees and obtain any required inspections of the work, prior to handover of the building.

Meters - The builder shall co-ordinate with the supply authority to ensure that a waterproof cabinet, by builder, is installed at an appropriate location for the installation of the meters.

Wiring - Wire to all light fittings, power outlets and appliances requiring direct connections. Provide provision to switchboard. All wiring shall be concealed.

Consumer Mains - Supply and install a mains, from the point of supply from the electricity supplier to the building. At the tender stage the builder shall determine the type of mains allowed-either underground or overhead and allow this in his tender price.

<u>Light Control Points</u> - Locate light switches 1000 from floor.

<u>GPO's</u> - Locate GPO's 300 from floor or 150 from the bench tops.

<u>TV Outlets</u> - Install TV points as per plan and extend line into ceiling space with 7 meters of spare line provided for connection to aerial.

Aerial is not in contract.

PLASTERER

<u>Plaster</u> - Supply and install flush set plasterboard to all walls and ceilings throughout the entire building unless noted otherwise on the plans. To the wet areas use water resistant plasterboard. At all corners install a metal backing angle. See plans for plaster thickness. All plasterboard shall be installed strictly in accordance with the manufacturers recommendations.

<u>Cornices</u> - To be selected by owner.

TILING

<u>Extent</u> - Extent of wall tiling to be confirmed by owner. See Plans for extent of floor tiles.

150 min high skirting tiling to wet ares. See plan for extent of floor

Adhesives - The builder shall use adhesives in accordance with the manufacturer's recommendations. Use flexible adhesives for floor tiles

 $\underline{\mathsf{Tiles}}$ - To be selected by client. Grout colours to be nominated by owner.

PAINTING

<u>Extent</u> - Paint all fascias, downpipes, verandah posts, eaves lining, doors, plasterboard, skirting, architraves and any other surfaces which are not pre-finished.

Standard - The builder shall apply a minimum of 2x coats to ensure that no blemishes or streaks occur. The builder shall apply additional coats if required. All work shall be carried out in accordance with the paint manufacturer's recommendations for preparation and application of the paints.

<u>Colours</u> - To be nominated by client.

Paint Type - External
Timber and metal - 2 coats of gloss acrylic
Downpipes - 2 coats of gloss acrylic
Eaves - 2 coats of matt acrylic

Paint Type - Internal

Doors - 2 coats of gloss enamel
Skirting & Architrave - 2 coats of gloss enamel
Walls - 2 coats of Wash N Wear acrylic
Ceiling - 2 coats of matt acrylic

CLEAN UP

The builder shall remove from the site any unused uilding materials, rubbish, etc. The builder shall level the site of any surplus soil, etc. The builder shall clean the windows & house generally, ready for occupation.

SIGN HERE

DATE:

NEW RESIDENCE LOT 10 (14B) LOMANDRA

COURT, YARRAWONGA,

VIC 3730

SCALE @ A3

ISSUE DATE

DRAWING STATUS
SALES STAGE

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